

1 SITE PLAN
SCALE: 1:20

GROSS FLOOR AREA	
UPPER FLOOR AREA	1,395 SF
MAIN FLOOR AREA	1460 SF
BASEMENT/LOWER AREA	1,299 SF
GARAGE AREA	506 SF
BASEMENT EXCLUSION	746 SF
STAIR EXCLUSION	69 SF
TOTAL GFA COVERAGE	3,775 SF
PERCENTAGE OF SITE AREA	7.53 %


LOT SLOPE CALC	
HIGHEST ELEVATION	126.5'
LOWEST ELEVATION	99.5'
ELEVATION DIFFERENCE	27'
HORIZ. DISTANCE	217.67'
$27/217.67 =$.124
LOT SLOPE	12.4%
LOT COVERAGE ALLOWED	40%
TOTAL COVER. ALLOWED	40%

LOT COVERAGE	
SITE AREA	11,154 SF
ALLOWED LOT COVERAGE	4,462 SF
MAIN STRUCTURE	1,903 SF
VEHICULAR USE	936 SF
COVERED PATIOS/DECKS	0 SF
TOTAL LOT COVERAGE	2,839 SF
LOT COVERAGE ALLOWED	40%
LOT COVERAGE PROPOSED	25.5 %

HARDSCAPE	
SITE AREA	11,154 SF
ALLOWED HARDSCAPE 9%	1,004 SF
WALKWAYS	403 SF
STAIRS	126 SF
RETAINING WALLS	128 SF
STAIR LANDING	183 SF
TOTAL HARDSCAPE AREA	840 SF
PERCENTAGE OF SITE AREA	7.53 %

AVERAGE BUILDING ELEV CALC			
WALL SEGMENT	MID-POINT ELEV (FT)	WALL LENGTH (FT)	TOTAL (FT)
A	122.50	40'	4,890'
B	116.75	48'	5,604'
C	109.00	21.5'	2,343.5'
D	110.00	10'	1,100'
E	110.75	18.5'	2,049'
F	116.50	38'	4,427'
TOTALS		176'	20,413.5'
$\frac{20,413.5}{176} = 116'$ AVERAGE BUILDING ELEVATION			

BASEMENT EXCLUSION CALC			
WALL SEGMENT	LENGTH	COVERAGE	RESULT
A	40'	100%	40
B	48'	50%	24
C	21.5'	0%	0
D	10'	0%	0
E	18.5'	0%	0
F	38'	33%	12.54
TOTALS	176		76.54
BASEMENT AREA: $1,736 \text{ SF} \times \frac{76.54}{176} = 746.05$ EXCLUDED			

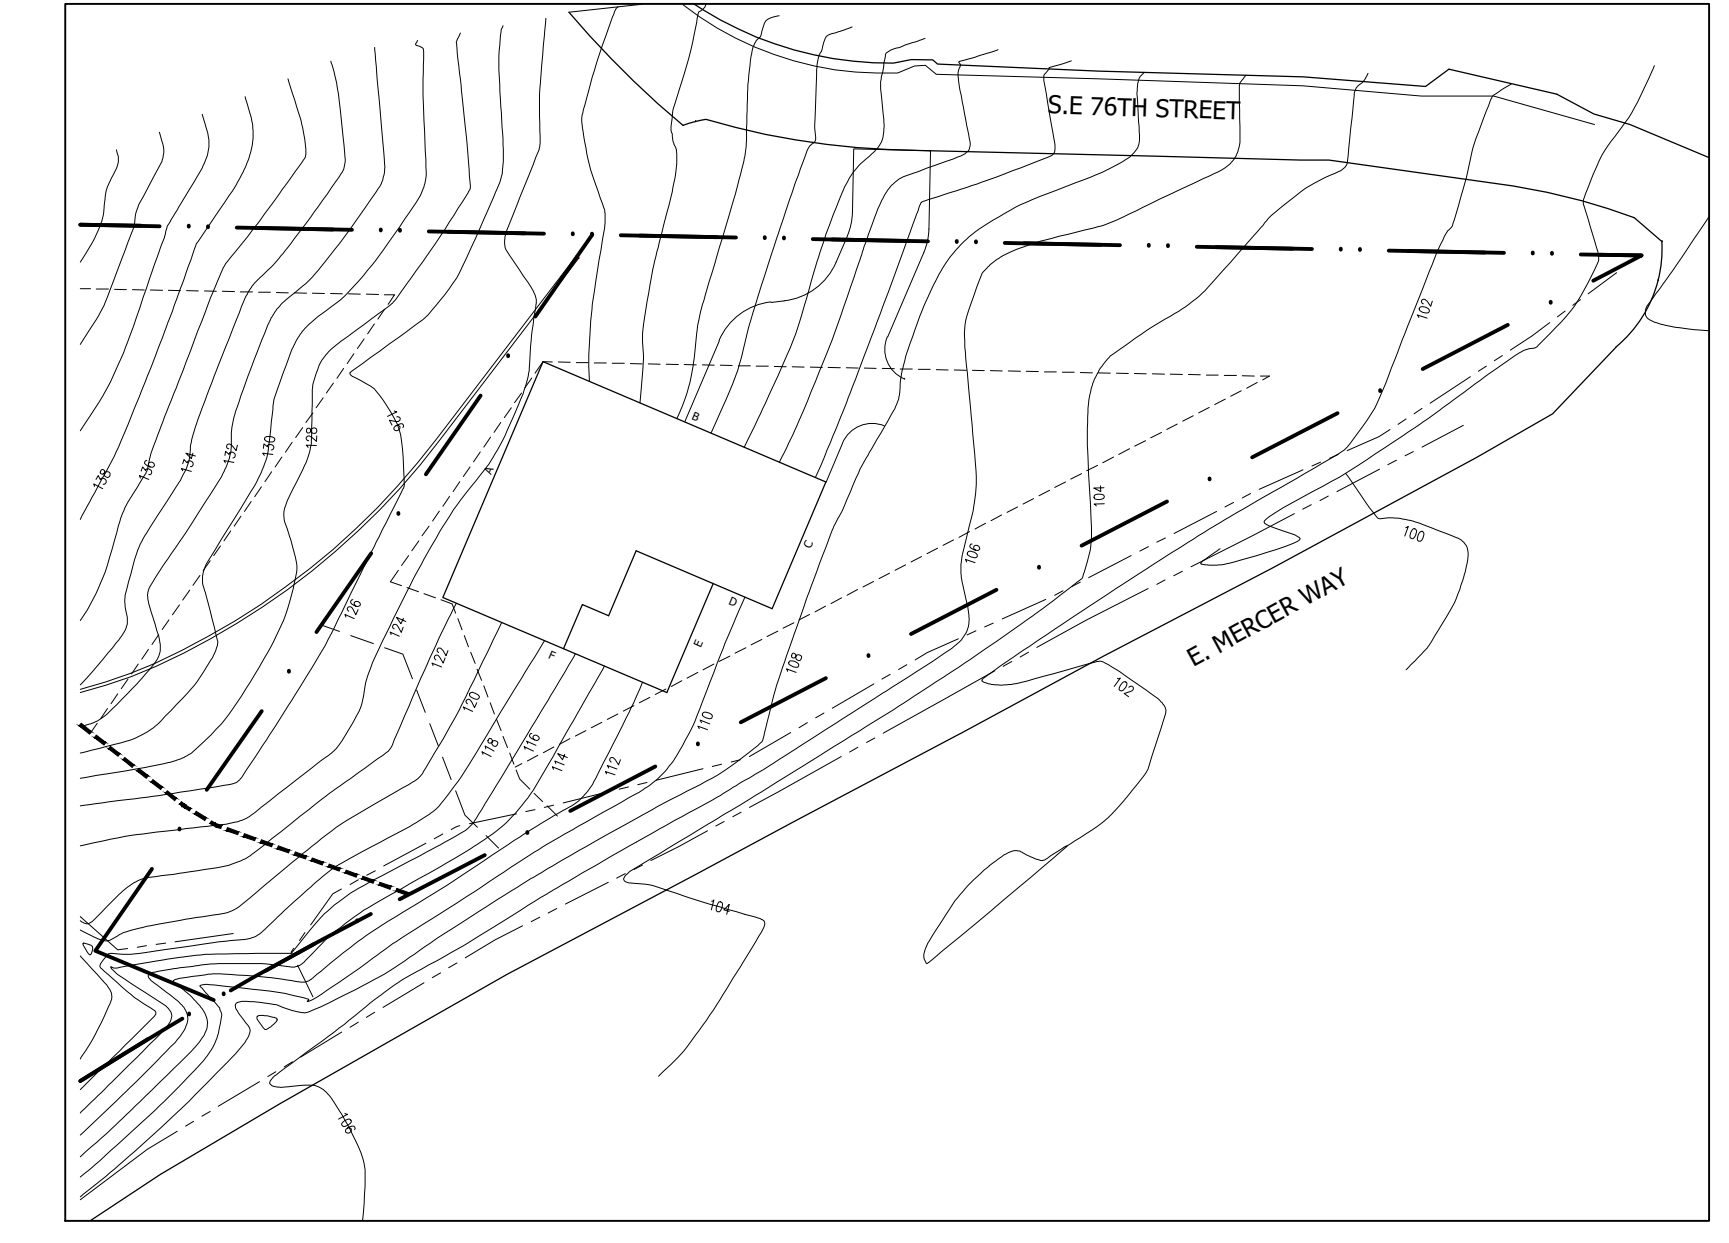

2 ABE PLAN
SCALE: 1:30



LEGAL DESCRIPTION
 NORTH 148.375 FEET OF GOVERNMENT LOT 6; EXCEPT THE WEST 1000 FEET ALSO THE NORTH 148.37 FEET OF A PORTION OF GOVERNMENT LOT 5 LYING WESTERLY OF EAST MERCER WAY. ALL IN SECTION 30, TOWNSHIP 24 NORTH, RANGE 5 EAST, W.M. IN KING COUNTY, WASHINGTON.

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 ELEVATION = 104.47'



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SURVEYOR'S NOTES

- 1) THE TOPOGRAPHIC SURVEY SHOWN HEREON WAS PERFORMED IN JULY OF 2013. THE FIELD DATA WAS COLLECTED AND RECORDED ON MAGNETIC MEDIA THROUGH AN ELECTRONIC THEODOLITE. THE DATA FILE IS ARCHIVED ON DISC OR CD. WRITTEN FIELD NOTES MAY NOT EXIST. CONTOURS ARE SHOWN FOR CONVENIENCE ONLY. DESIGN SHOULD RELY ON SPOT ELEVATIONS.
- 2) SUBJECT PROPERTY TAX PARCEL NO. 3024059036.
- 3) SUBJECT PROPERTY AREA PER THIS SURVEY IS 88,557 SQ.FT. +/-.
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LEGEND

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TOPOGRAPHIC & BOUNDARY SURVEY

JOB NUMBER: 13507	
DATE: 07/09/2013	
DRAFTED BY: Y.L.J.	
CHECKED BY: E.J.G.	
SCALE: 1" = 30'	
REVISION HISTORY	REVISION HISTORY
DATE: 06/20/2016	DATE: 01/26/2016
DATE: 07/12/2016	SHEET NUMBER
DATE: 03/24/2017	1 OF 1

Terrane
 10801 Main Street, Suite 102, Bellevue, WA 98004
 phone 425.458.4488 support@terrane.net
 www.terrane.net

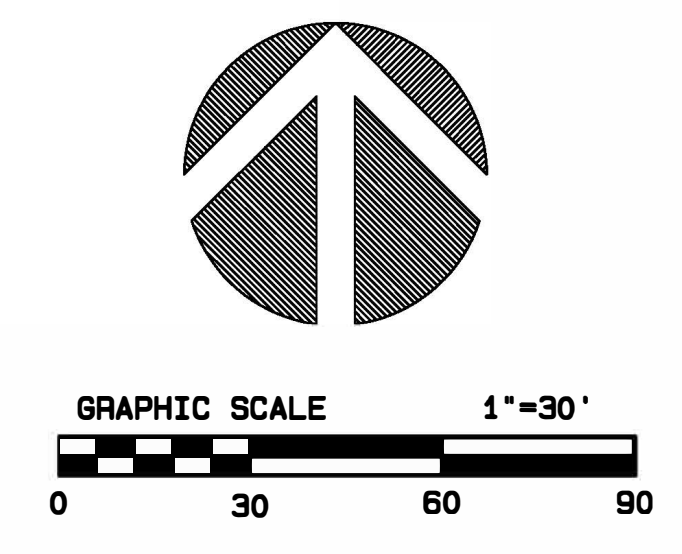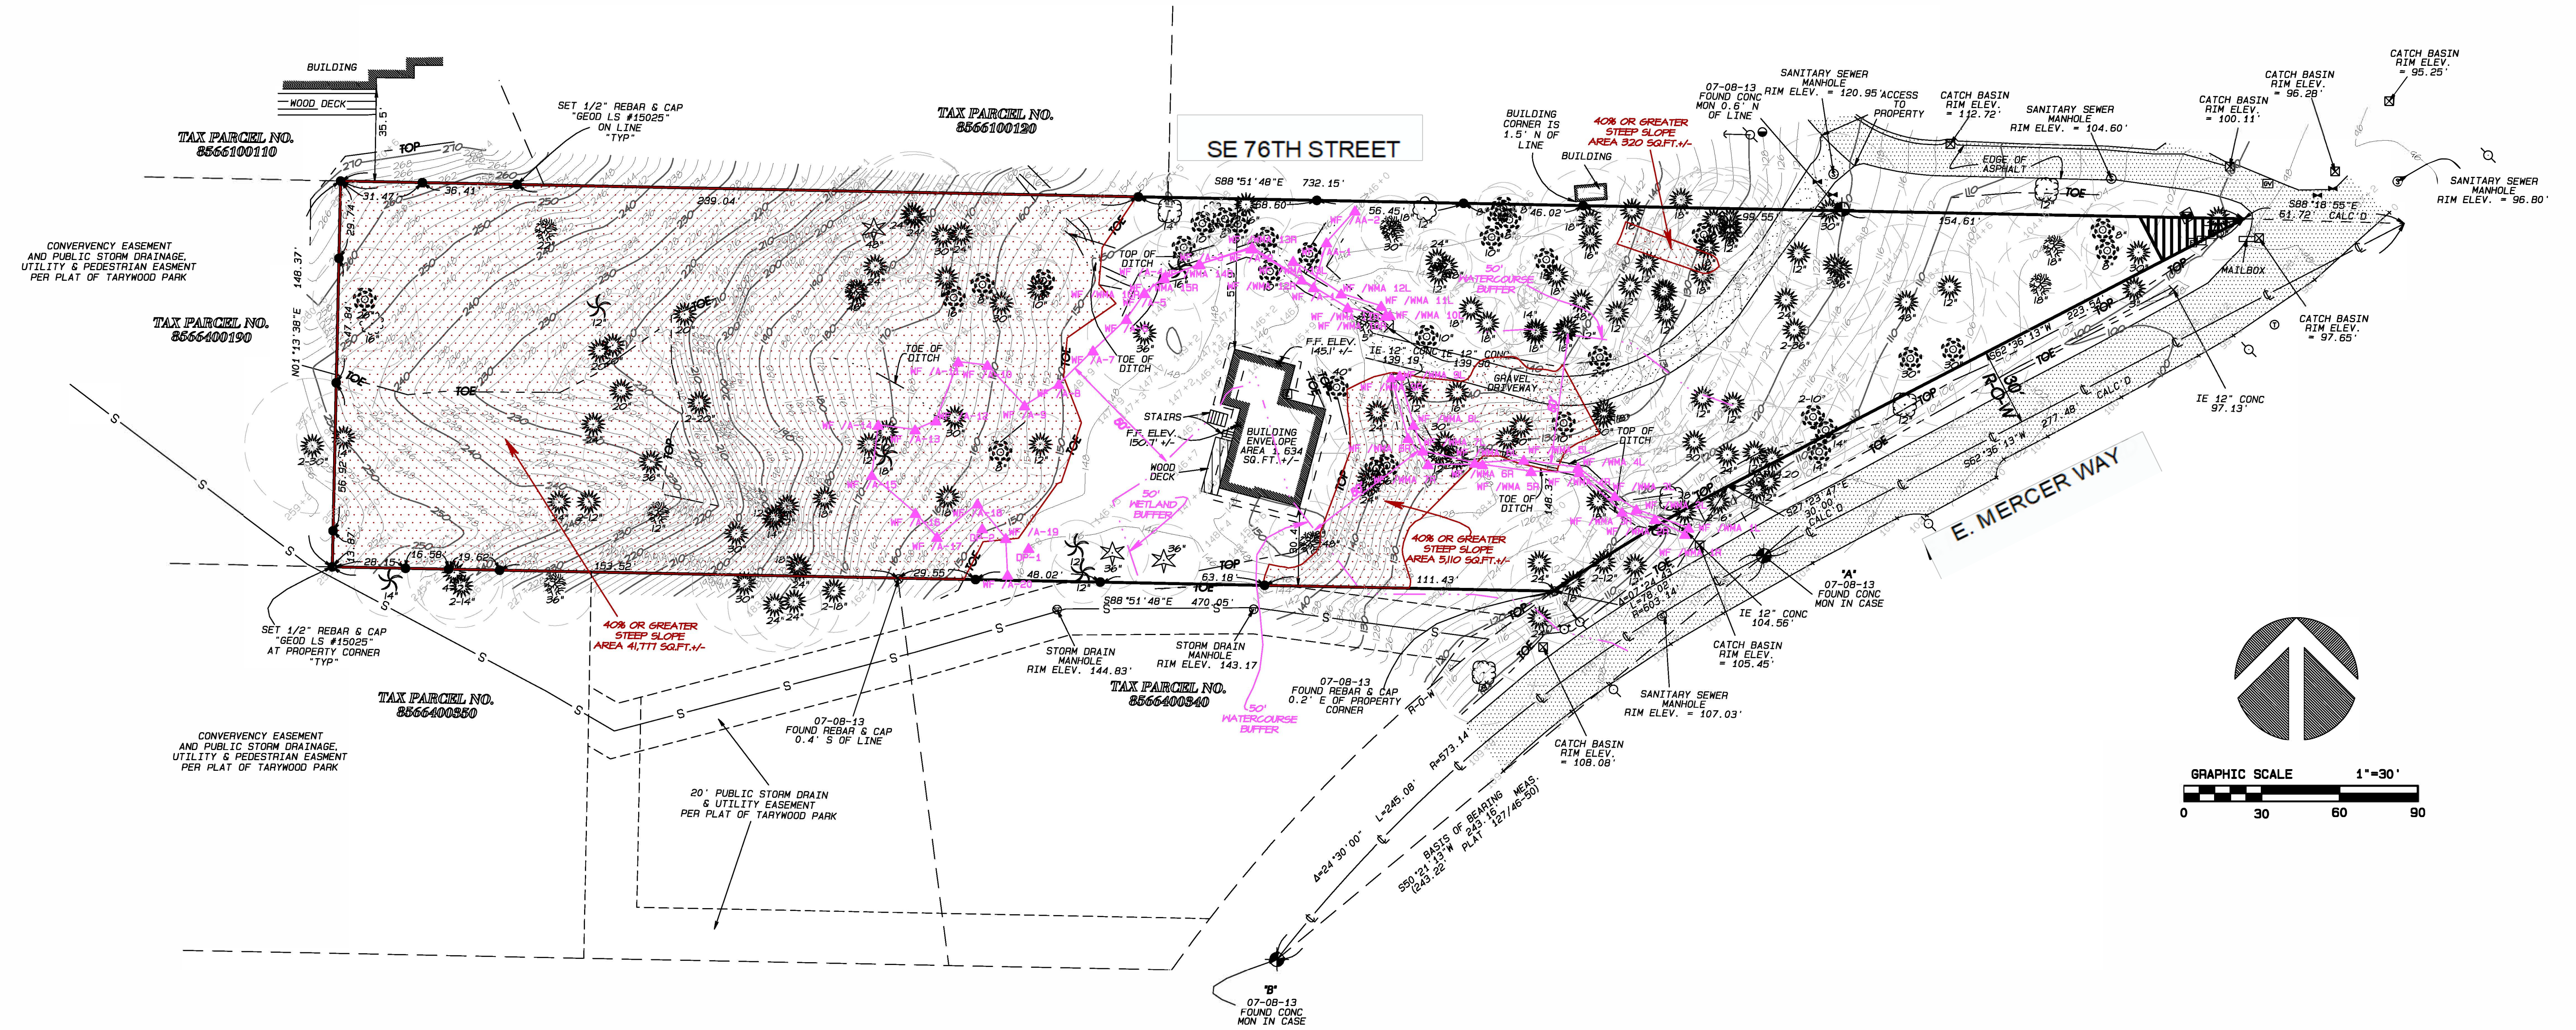

TOPOGRAPHIC & BOUNDARY SURVEY
 NE 1/4 OF THE SW 1/4 AND THE NW 1/4 OF THE SE 1/4 OF SEC. 30, TWP. 24N., RGE. 5E., W.M. CITY OF MERCER ISLAND, KING COUNTY, WA.

CHESHIRE RESIDENCE
 7615 E. MERCER WAY
 MERCER ISLAND, WA. 98040

measure success

BUILDING PERMIT PLANS FOR

CHESHIRE SHORT PLAT LOT 1

DEREK CHESHIRE

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SETBACKS



	CODE	PROPOSED
FRONT		20'
SIDE		VARIABLE SEE MICC 19.02.020(C)(1)(c)(iii)
REAR		25'

SITE STATISTICS

PARCEL NO:	302405-9036
TOTAL AREA: (+/-)	92,347 S.F. (2.12± ACRES)
PROPOSED NUMBER OF LOTS	2
MAXIMUM UNITS:	2
ZONING	R-9.6
EXISTING USE:	SINGLE FAMILY RESIDENTIAL
PROPOSED USE:	SINGLE FAMILY RESIDENTIAL
MAXIMUM BUILDING HEIGHT:	30' ABOVE TO THE HIGHEST POINT OF THE ROOF
MAXIMUM IMPERVIOUS SURFACE:	

LOT SLOPE	LOT COVERAGE (LIMIT FOR IMPERVIOUS SURFACE)
LESS THAN 15%	40%*
15% TO LESS THAN 30%	35%
30% TO 50%	30%
GREATER THAN 50% SLOPE	20%

LOT 1 HAS A SLOPE OF 12%. THEREFORE THE MAXIMUM LOT COVERAGE IS 40% OR 4,461 SF.

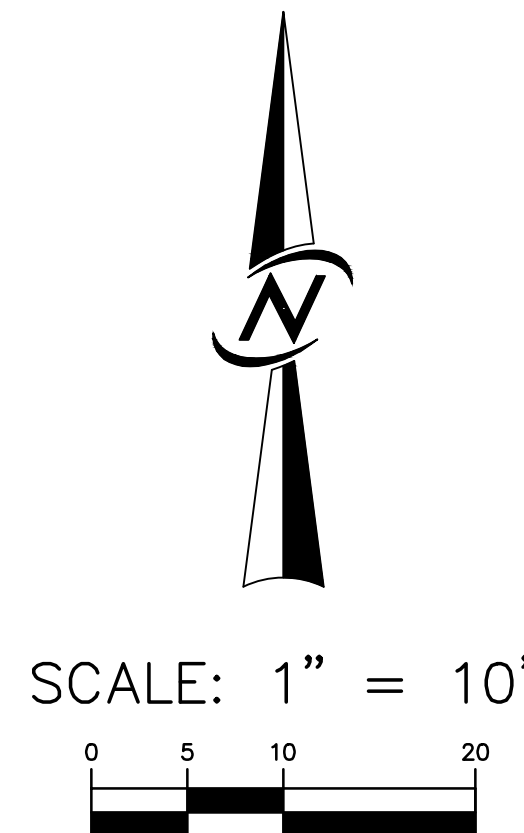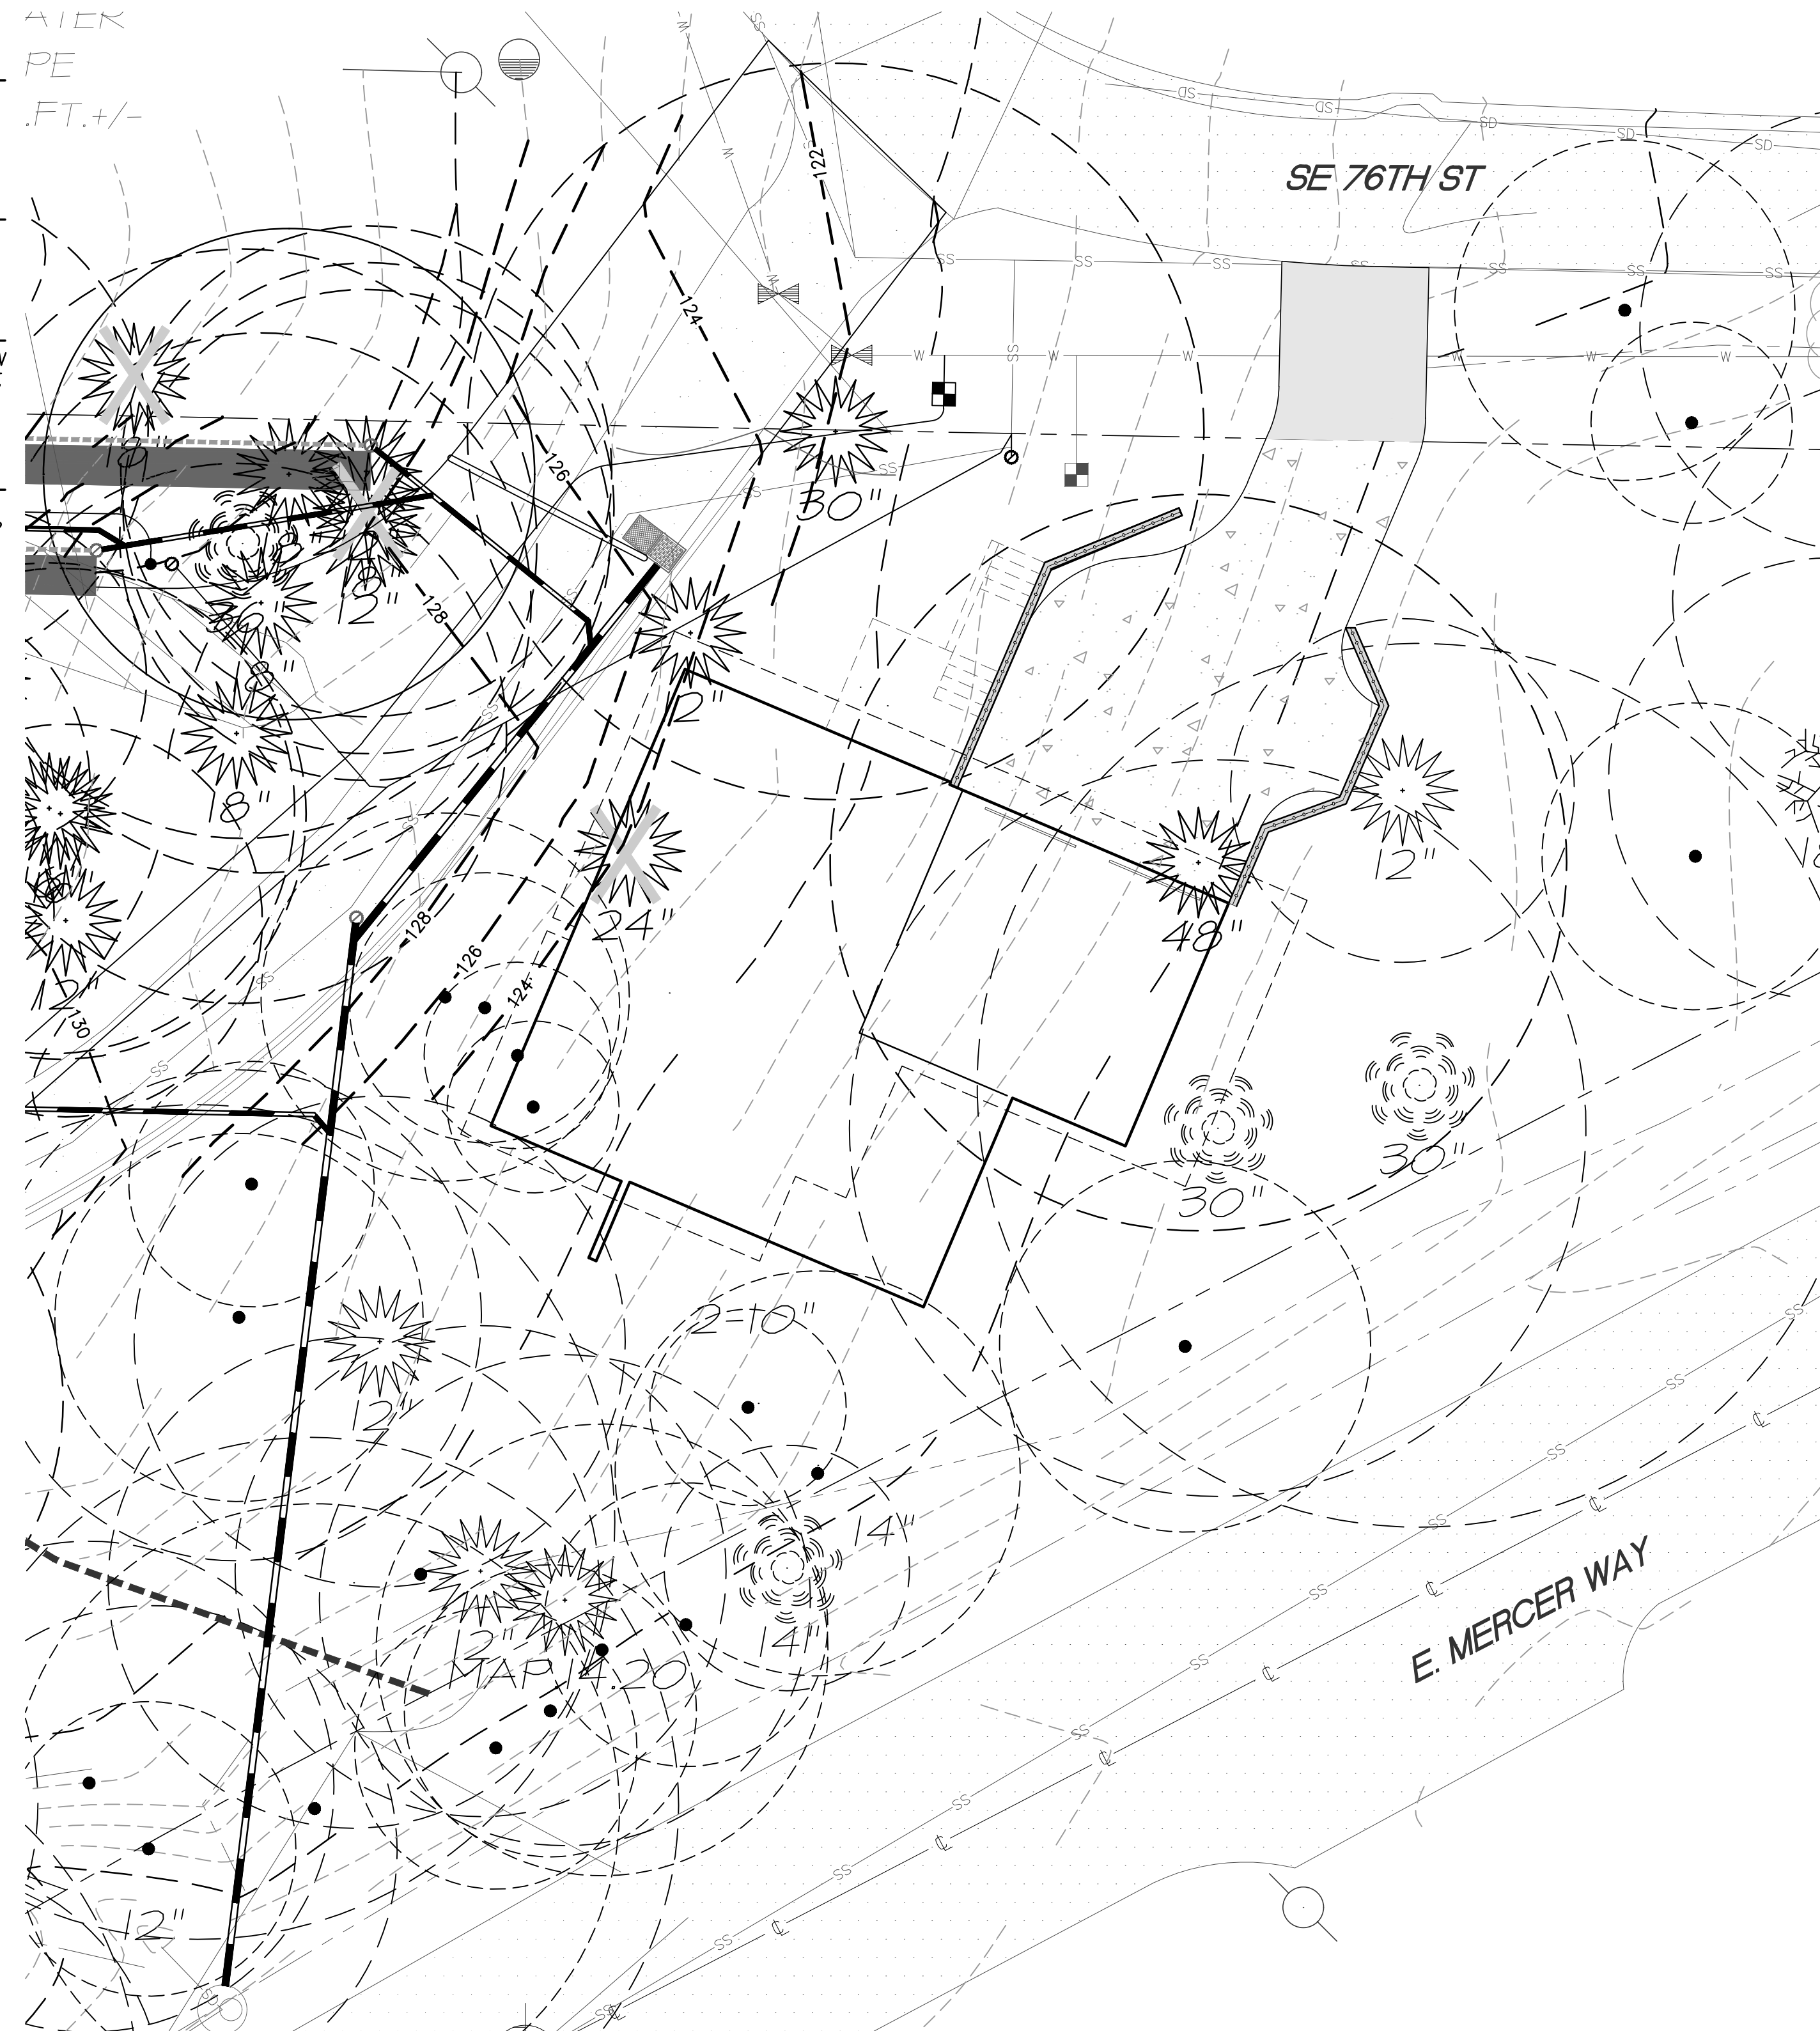

SHEET INDEX

C1.01	TITLE SHEET
C2.01	PRELIMINARY SHORT PLAT
C3.01	ROAD, GRADING & STORM DRAINAGE PLAN
C3.21	STORMWATER DETAILS
C4.01	TREE PLAN

APPLICANT/OWNER

DEREK CHESHIRE
7615 MERCER WAY
MERCER ISLAND, WA 98040
DCHESHIRE@BOSKONE.NET

ENGINEER

CORE DESIGN, INC.
12100 NE 195TH ST, SUITE 300
BOTHELL, WA 98011
(425) 885-7877
CONTACT: SHERI MURATA, P.E. - ENGINEER
SHM@COREDESIGNINC.COM

SURVEYOR


TERRANE
10801 MAIN STREET, SUITE 102
BELLEVUE, WA 98004
(425) 458-4488
CONTACT: EDWIN J. GREEN
SUPPORT@TERRANE.NET

ARBORIST

A.B.C. CONSULTING ARBORISTS, LLC
DANIEL J. MAPLE
(509) 953-0293
DANIEL@ABCARBORIST.COM

GEOTECHNICAL ENGINEER

TERRA ASSOCIATES, INC.
12220 113TH AVENUE NE, SUITE 130
KIRKLAND, WA 98034
(425) 821-7777
CONTACT CAROLYN DECKER

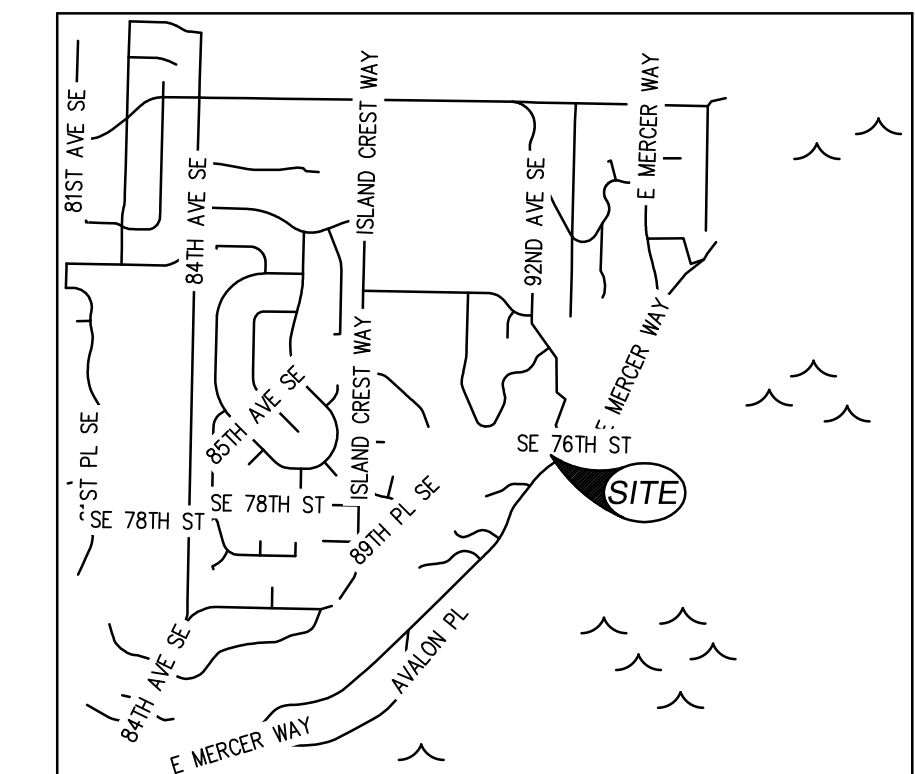

VICINITY MAP
NOT TO SCALE

UNDERGROUND LOCATOR SERVICE
CALL BEFORE YOU DIG!
811

PERMIT NO: 2021-XXX

DATE	DESIGNED	DRAWN	APPROVED	PROJECT MANAGER	SHEET	OF	PROJECT NUMBER
JULY 2020 (1ST SUB)	SHERI MURATA, P.E.	SAM D. SIMPSON-GORDON	SHERI MURATA, P.E.	ROBERT WEST, PLS	1	5	19205

**CIVIL ENGINEERING
LANDSCAPE ARCHITECTURE
PLANNING
SURVEYING**

CORE DESIGN

12100 NE 195th St, Suite 300 Bothell, Washington 98011 425.885.7877


TITLE SHEET

CHESHIRE SHORT PLAT LOT 1

DEREK CHESHIRE

7615 E MERCER WAY
MERCER ISLAND, WA 98040

9/2/2021 8:02 AM v.1201919205 (ENGINEERING) FINAL (SHEETS) 19205_C1.DWG

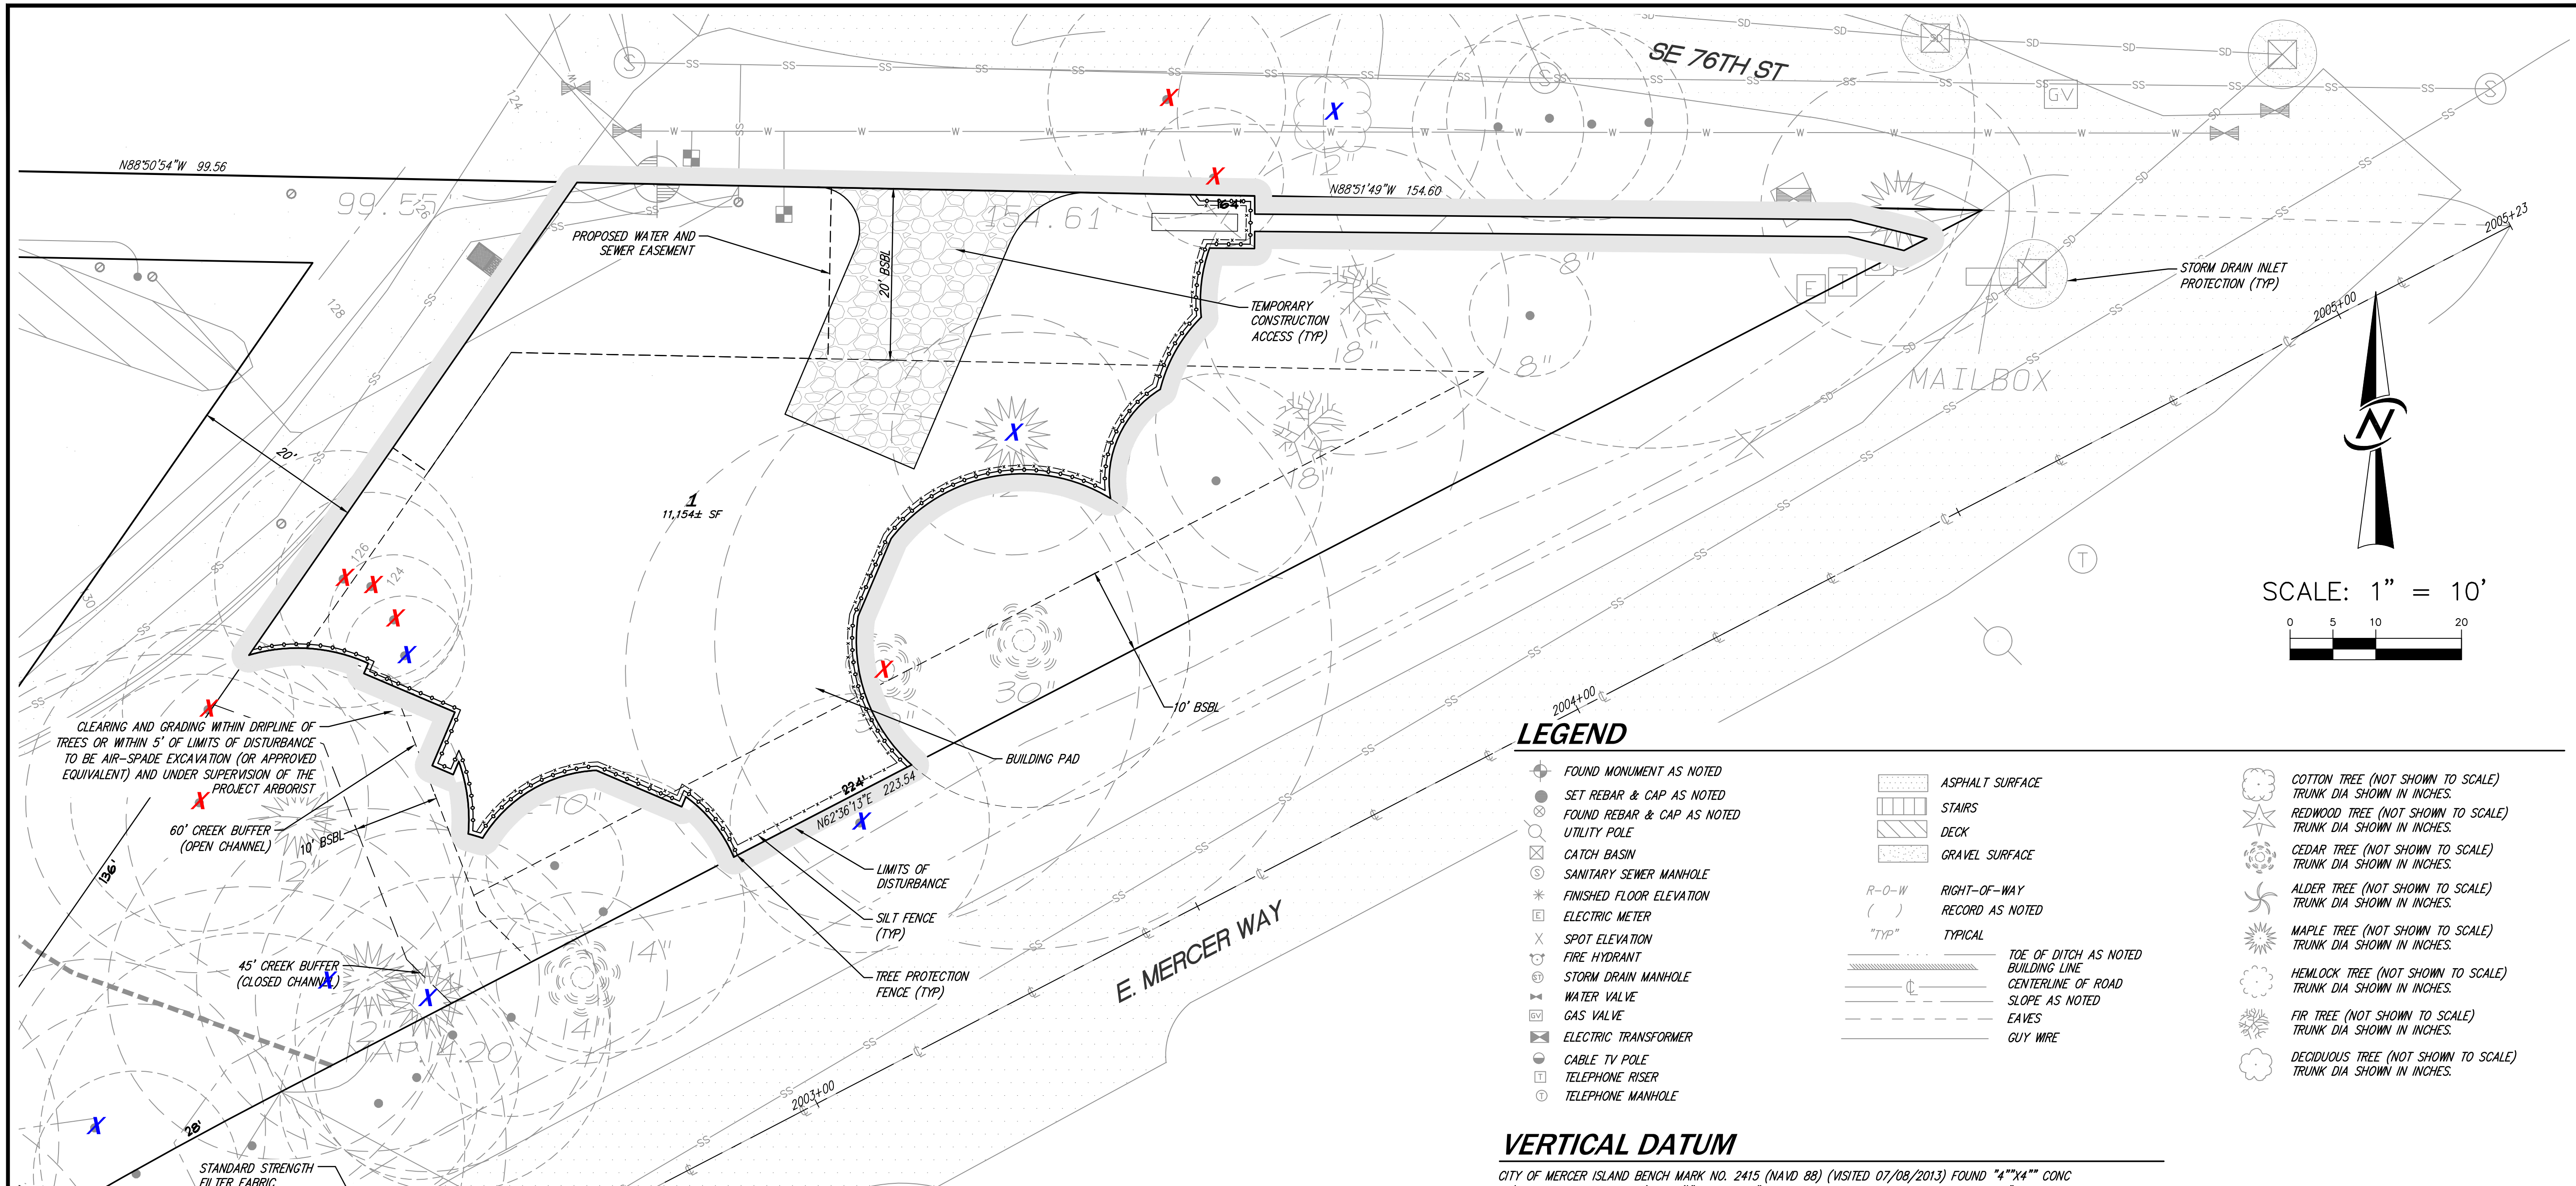

LEGEND

- FOUND MONUMENT AS NOTED
- SET REBAR & CAP AS NOTED
- ⊗ FOUND REBAR & CAP AS NOTED
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- ▩ DECK
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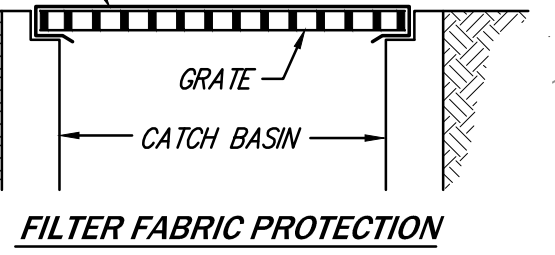
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CLEARING AND GRADING WITHIN DRIPLINE OF TREES OR WITHIN 5' OF LIMITS OF DISTURBANCE TO BE AIR-SPADE EXCAVATION (OR APPROVED EQUIVALENT) AND UNDER SUPERVISION OF THE PROJECT ARBORIST

60' CREEK BUFFER (OPEN CHANNEL)


45' CREEK BUFFER (CLOSED CHANNEL)

NOTE: ONLY TO BE USED WHERE PONDING OF WATER ABOVE THE CATCH BASIN WILL NOT CAUSE TRAFFIC PROBLEMS AND WHERE OVERFLOW WILL NOT RESULT IN EROSION OF SLOPES.




FILTER FABRIC PROTECTION

NOTE: THIS DETAIL IS ONLY SCHEMATIC. ANY INSERT IS ALLOWED THAT HAS A MIN. 0.5 C.F. OF STORAGE. THIS MEANS TO DEWATER THE STORED SEDIMENT, AN OVERFLOW, AND CAN BE EASILY MAINTAINED.

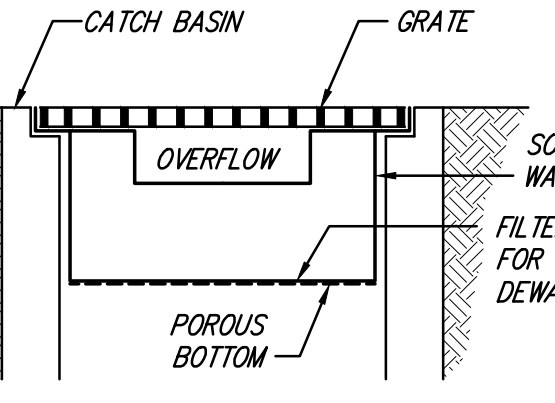

CATCH BASIN INSERT

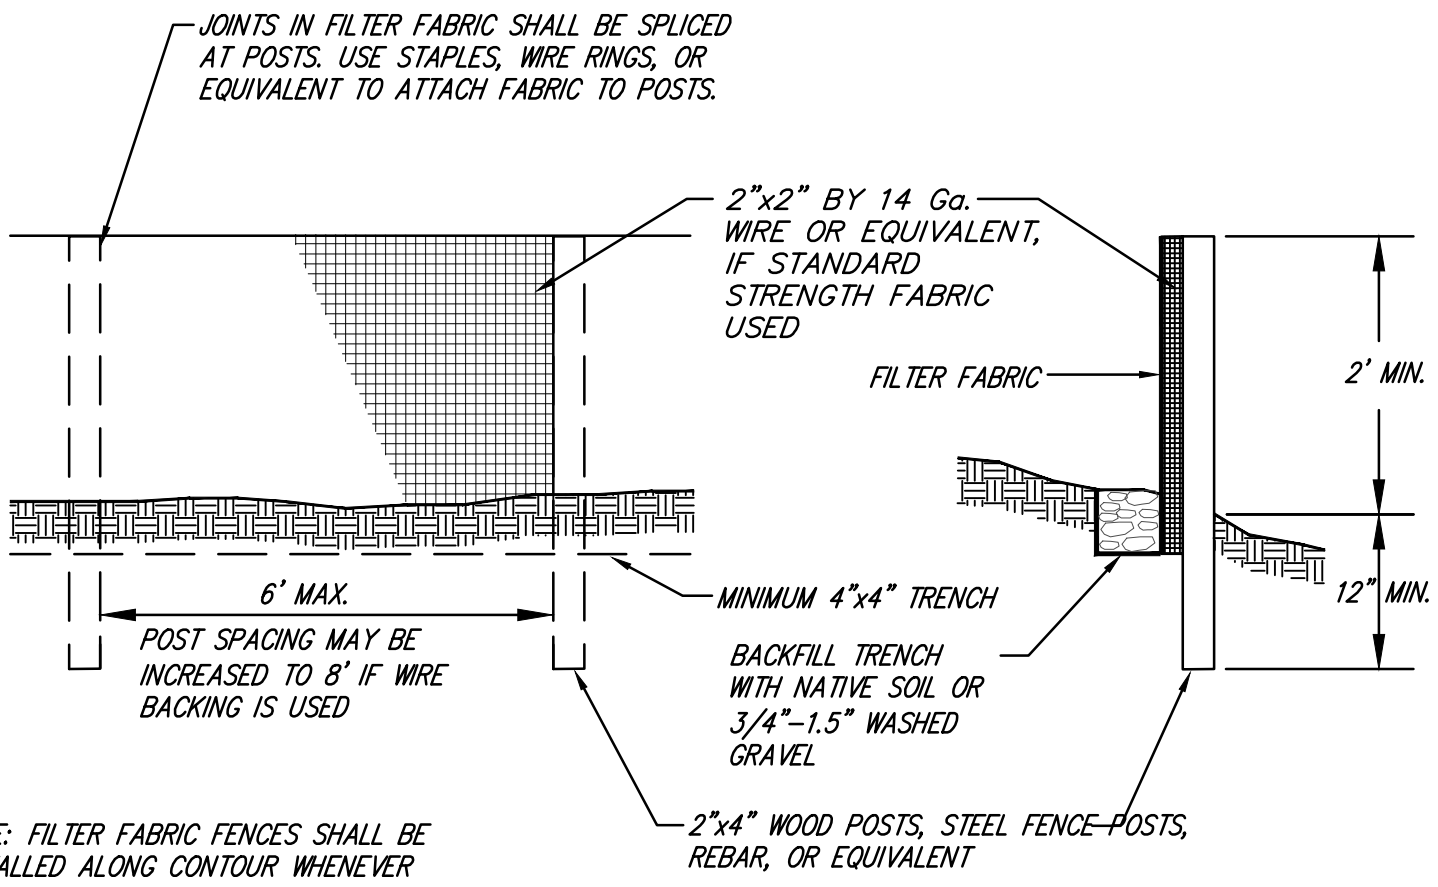

NOTE: FILTER FABRIC FENCES SHALL BE INSTALLED ALONG CONTOUR WHENEVER POSSIBLE

FILTER FABRIC FENCE DETAIL

MAINTENANCE STANDARDS

- ANY ACCUMULATED SEDIMENT ON OR AROUND THE FILTER FABRIC PROTECTION SHALL BE REMOVED IMMEDIATELY. SEDIMENT SHALL NOT BE REMOVED WITH WATER, AND ALL SEDIMENT MUST BE DISPOSED OF AS FILL ON-SITE OR HAULED OFF-SITE.
- ANY SEDIMENT IN THE CATCH BASIN INSERT SHALL BE REMOVED WHEN THE SEDIMENT HAS FILLED ONE-THIRD OF THE AVAILABLE STORAGE. THE FILTER MEDIA FOR THE INSERT SHALL BE CLEANED OR REPLACED AT LEAST MONTHLY.
- REGULAR MAINTENANCE IS CRITICAL FOR BOTH FORMS OF CATCH BASIN PROTECTION. UNLIKE MANY FORMS OF PROTECTION THAT FAIL GRADUALLY, CATCH BASIN PROTECTION WILL FAIL SUDDENLY AND COMPLETELY IF NOT MAINTAINED PROPERLY.

FILTER FABRIC PROTECTION FOR CB's

NO SCALE

NO SCALE


DATE	JULY 2020 (1ST SUB)
DESIGNED	SHERI MURATA, P.E.
DRAWN	SAM D. SIMPSON-GORDON
APPROVED	SHERI MURATA, P.E.
PROJECT MANAGER	ROBERT WEST, PLS
SHEET	2
OF	5
PROJECT NUMBER	19205

TESC PLAN
CHESHIRE SHORT PLAT LOT 1
DEREK CHESHIRE
 7615 E MERCER WAY
 MERCER ISLAND, WA 98040

CIVIL ENGINEERING
 LANDSCAPE ARCHITECTURE
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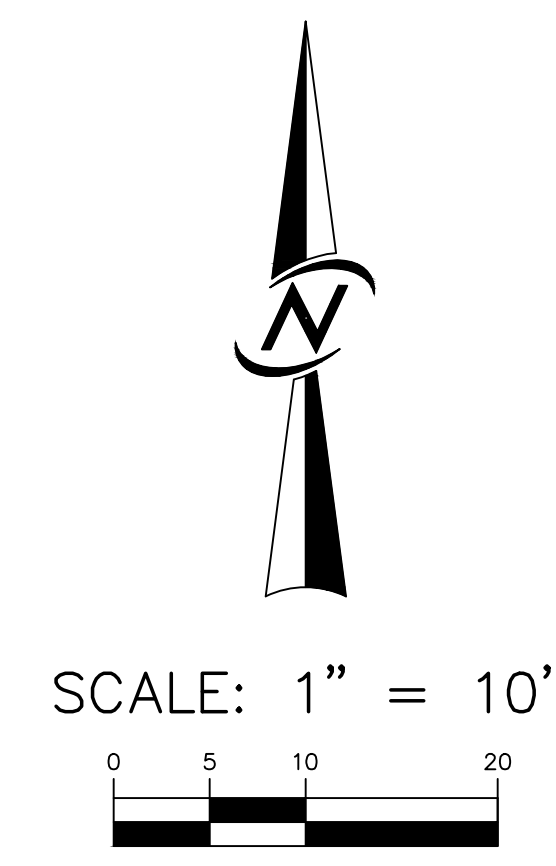
CORE DESIGN
 12100 NE 195th St, Suite 300 Bothell, Washington 98011 425.885.7877

PERMIT NO: 2021-XXX
 811
 UNDERGROUND LOCATOR SERVICE
 CALL BEFORE YOU DIG!

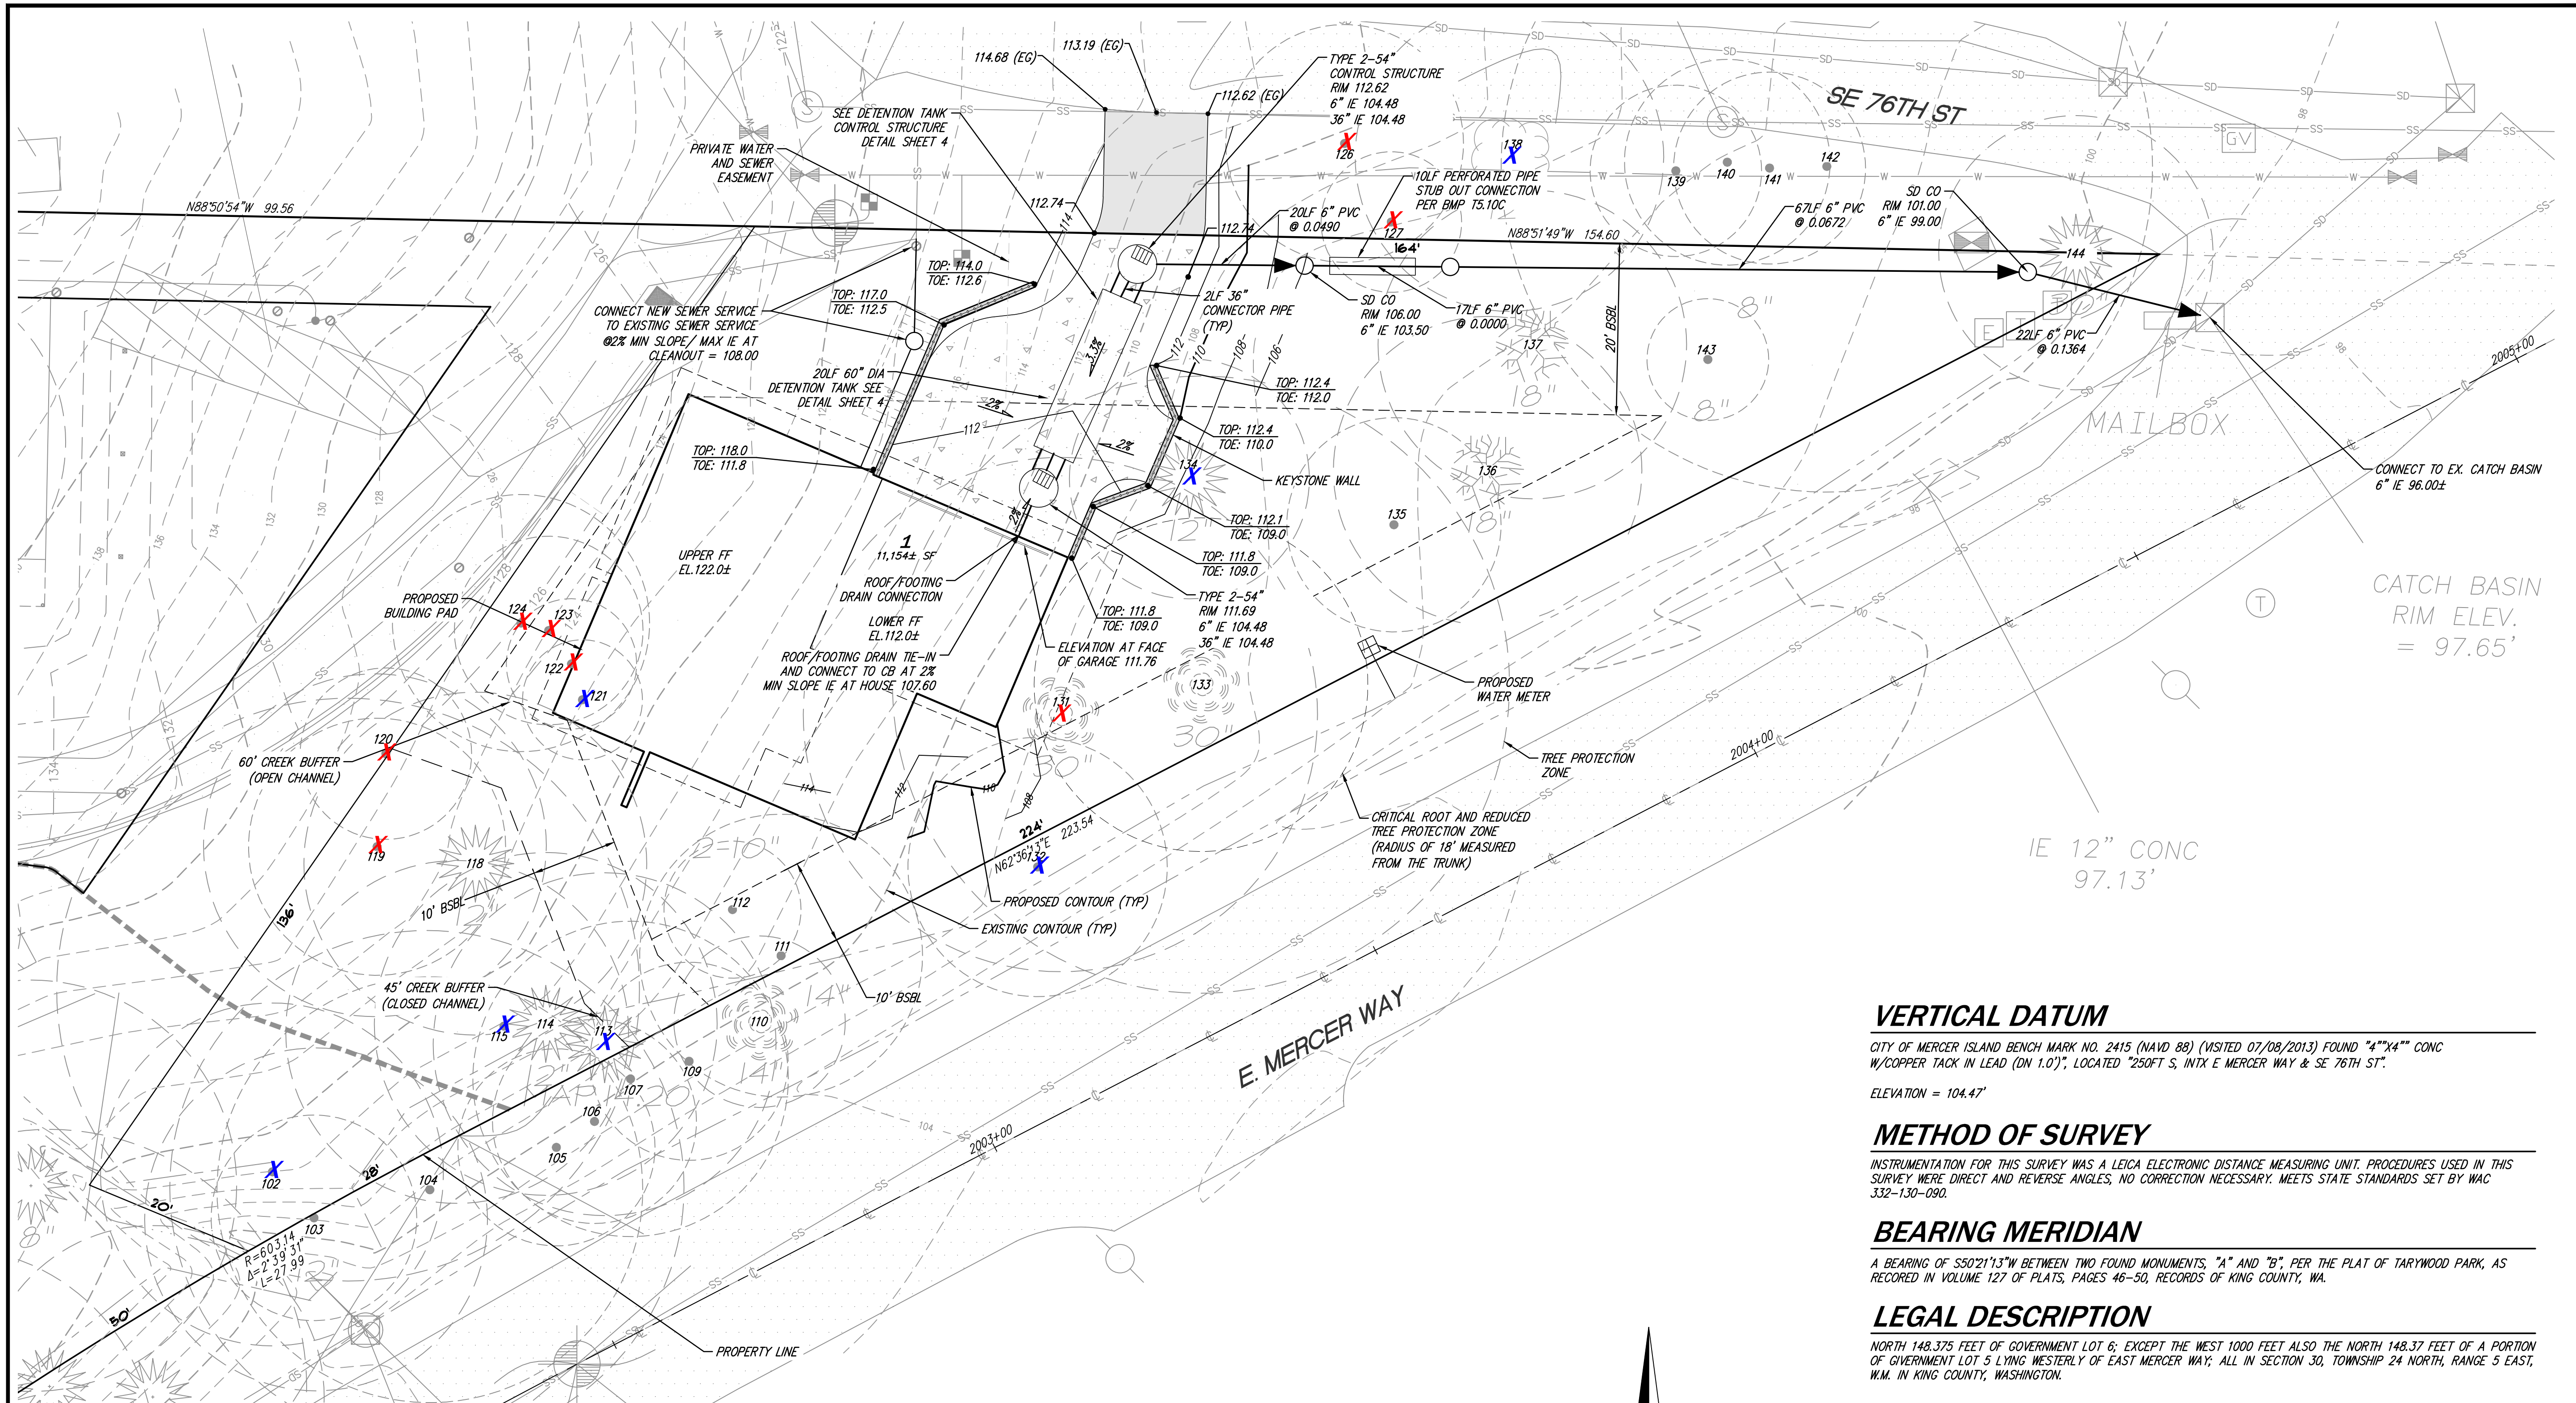

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- | | | | |
|--|---|---|---|
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|--|---|---|---|



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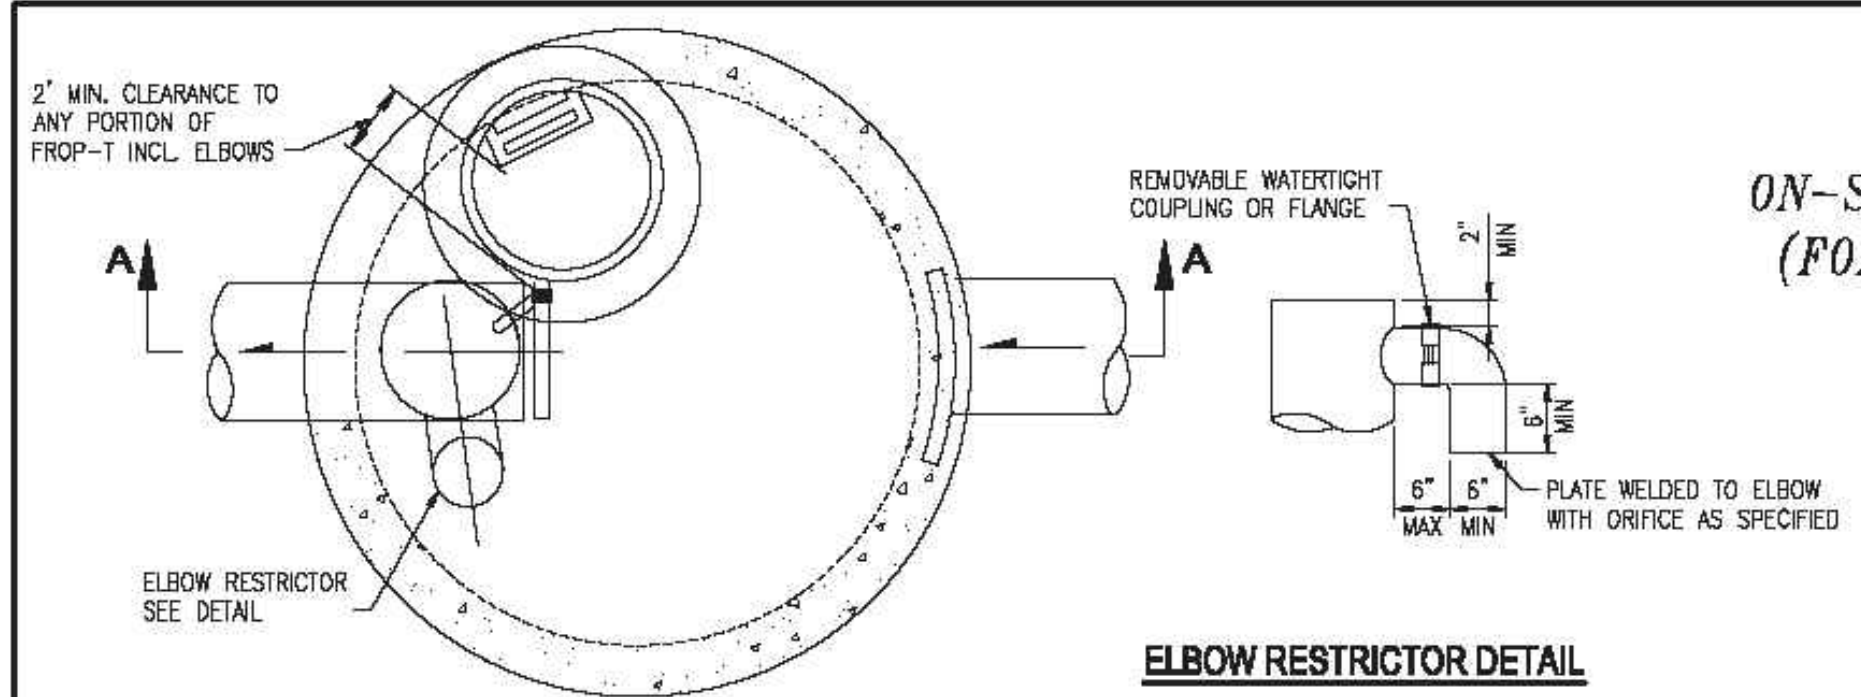
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CALL BEFORE YOU DIG!
811

PERMIT NO: 2021-XXX

DATE		REVISIONS					
DESIGNED	SHERI MURATA, P.E.	DRAWN	SAM D. SIMPSON-GORDON	APPROVED	SHERI MURATA, P.E.	PROJECT MANAGER	ROBERT WEST, PLS
DATE	JULY 2020 (IST SUB)	SHEET	OF	PROJECT NUMBER	19205		
ROAD, GRADING & STORM DRAINAGE PLAN		CHESHIRE SHORT PLAT LOT 1		DEREK CHESHIRE		7615 E MERCER WAY MERCER ISLAND, WA 98040	
				CORE DESIGN		CIVIL ENGINEERING LANDSCAPE ARCHITECTURE PLANNING SURVEYING 12100 NE 195th St, Suite 300 Bothell, Washington 98011 425.885.7877	
						7-27-2021	


9/2/2021 8:02 AM 4/20/19 19205 (ENGINEERING) FINAL (SHEET) 19205 CS 01.DWG

**ATTACHMENT 1
CITY OF MERCER ISLAND
ON-SITE DETENTION SYSTEM WORKSHEET
(FOR NEW PLUS REPLACED IMPERVIOUS
AREA OF 9,500 SF OR LESS)**




ELBOW RESTRICTOR DETAIL

OWNER: <u>DEREK CHESHIRE</u>	ADDRESS: <u>7615 E MERCER WAY, MERCER ISLAND, WA 98040</u>	PREPARED BY: <u>SHERI MURATA, P.E.</u>
PERMIT #:		PHONE: <u>425-885-7877</u>
		DATE: <u>7/23/2021</u>
NEW PLUS REPLACED IMPERVIOUS SURFACE AREA (SF): <u>2,677</u>	DETENTION PIPE DIA (INCH): <u>60"</u>	DETENTION PIPE LENGTH (FT): <u>20</u>
SOIL TYPE: <u>C</u>	PIPE MATERIAL: <u>CMP</u>	ORIFICE #1 DIA <u>0.5"</u> INCH, ELEV <u>104.48</u>
		ORIFICE #2 DIA <u>1.1"</u> INCH, ELEV <u>108.18</u>

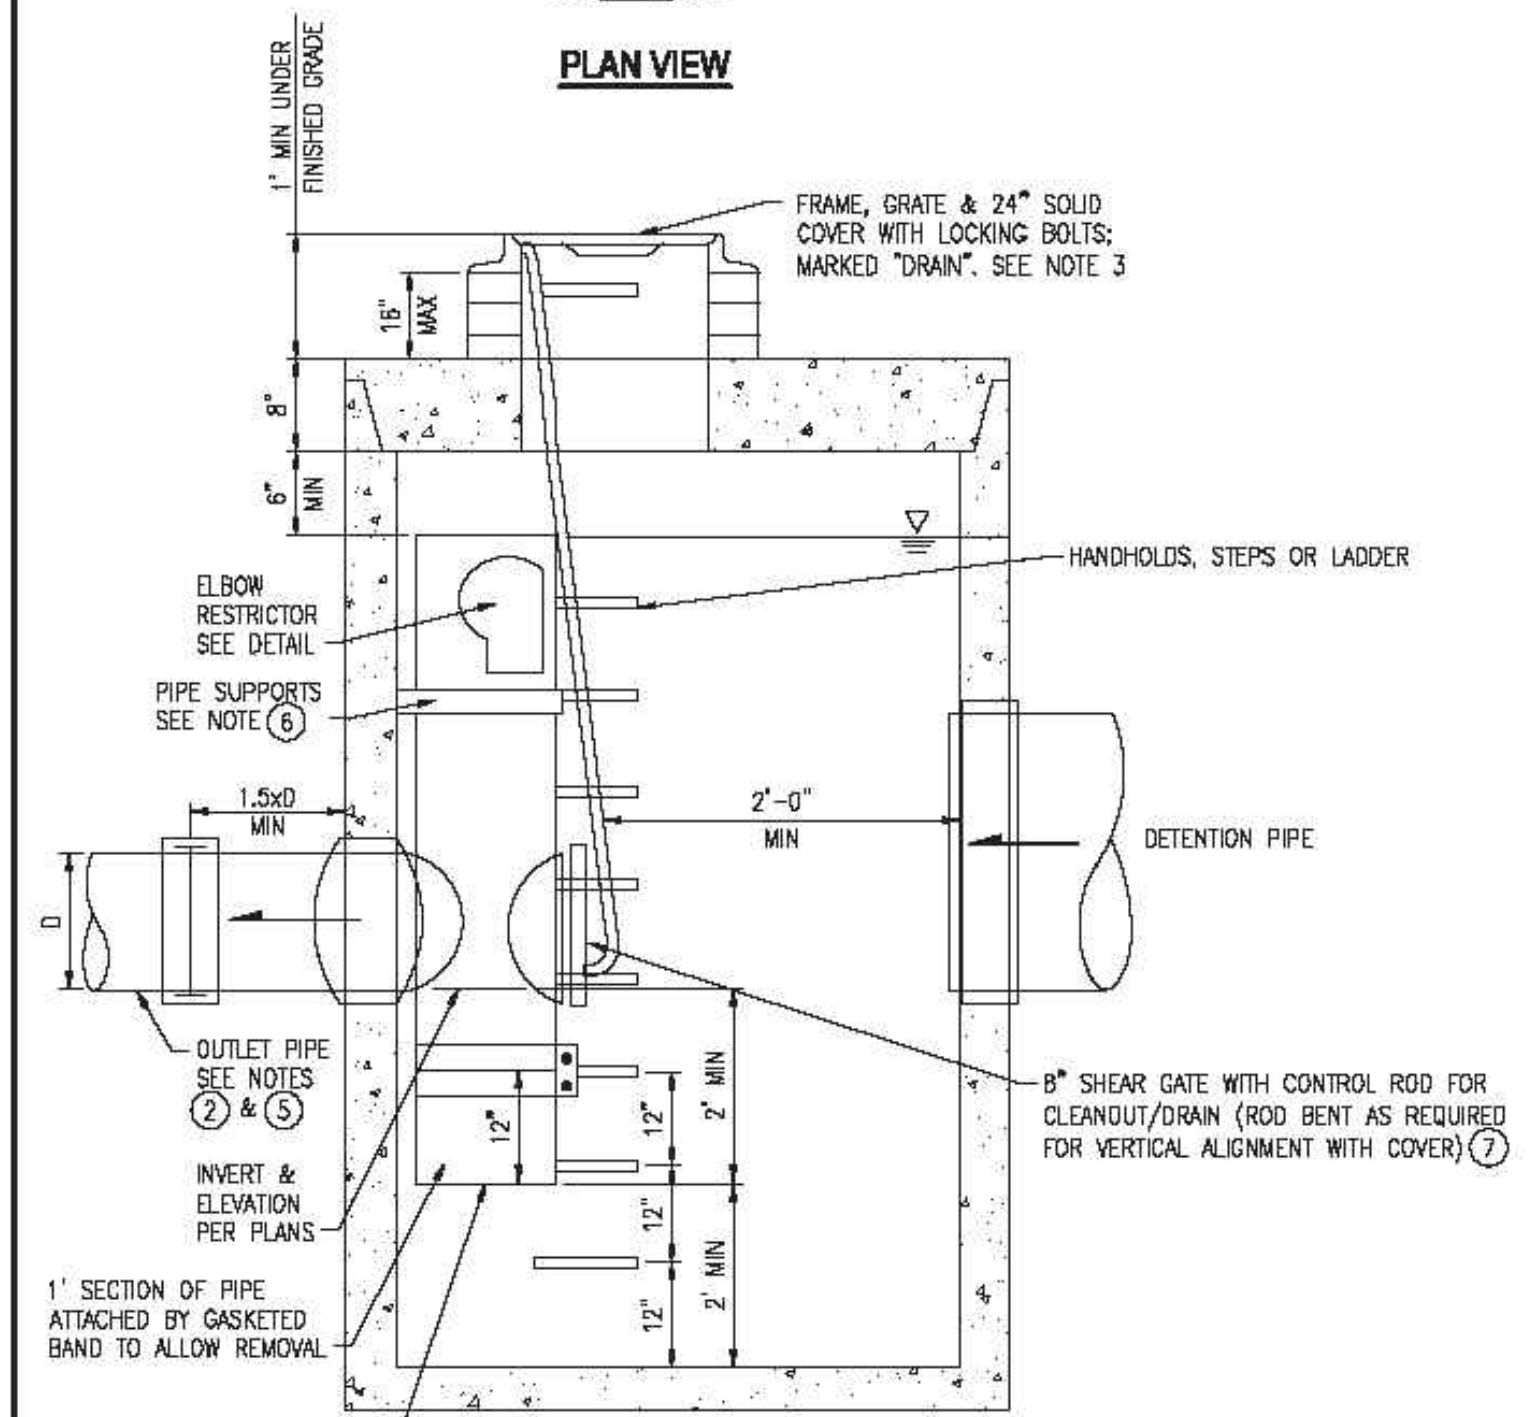

SECTION A-A CONTROL STRUCTURE DETAIL

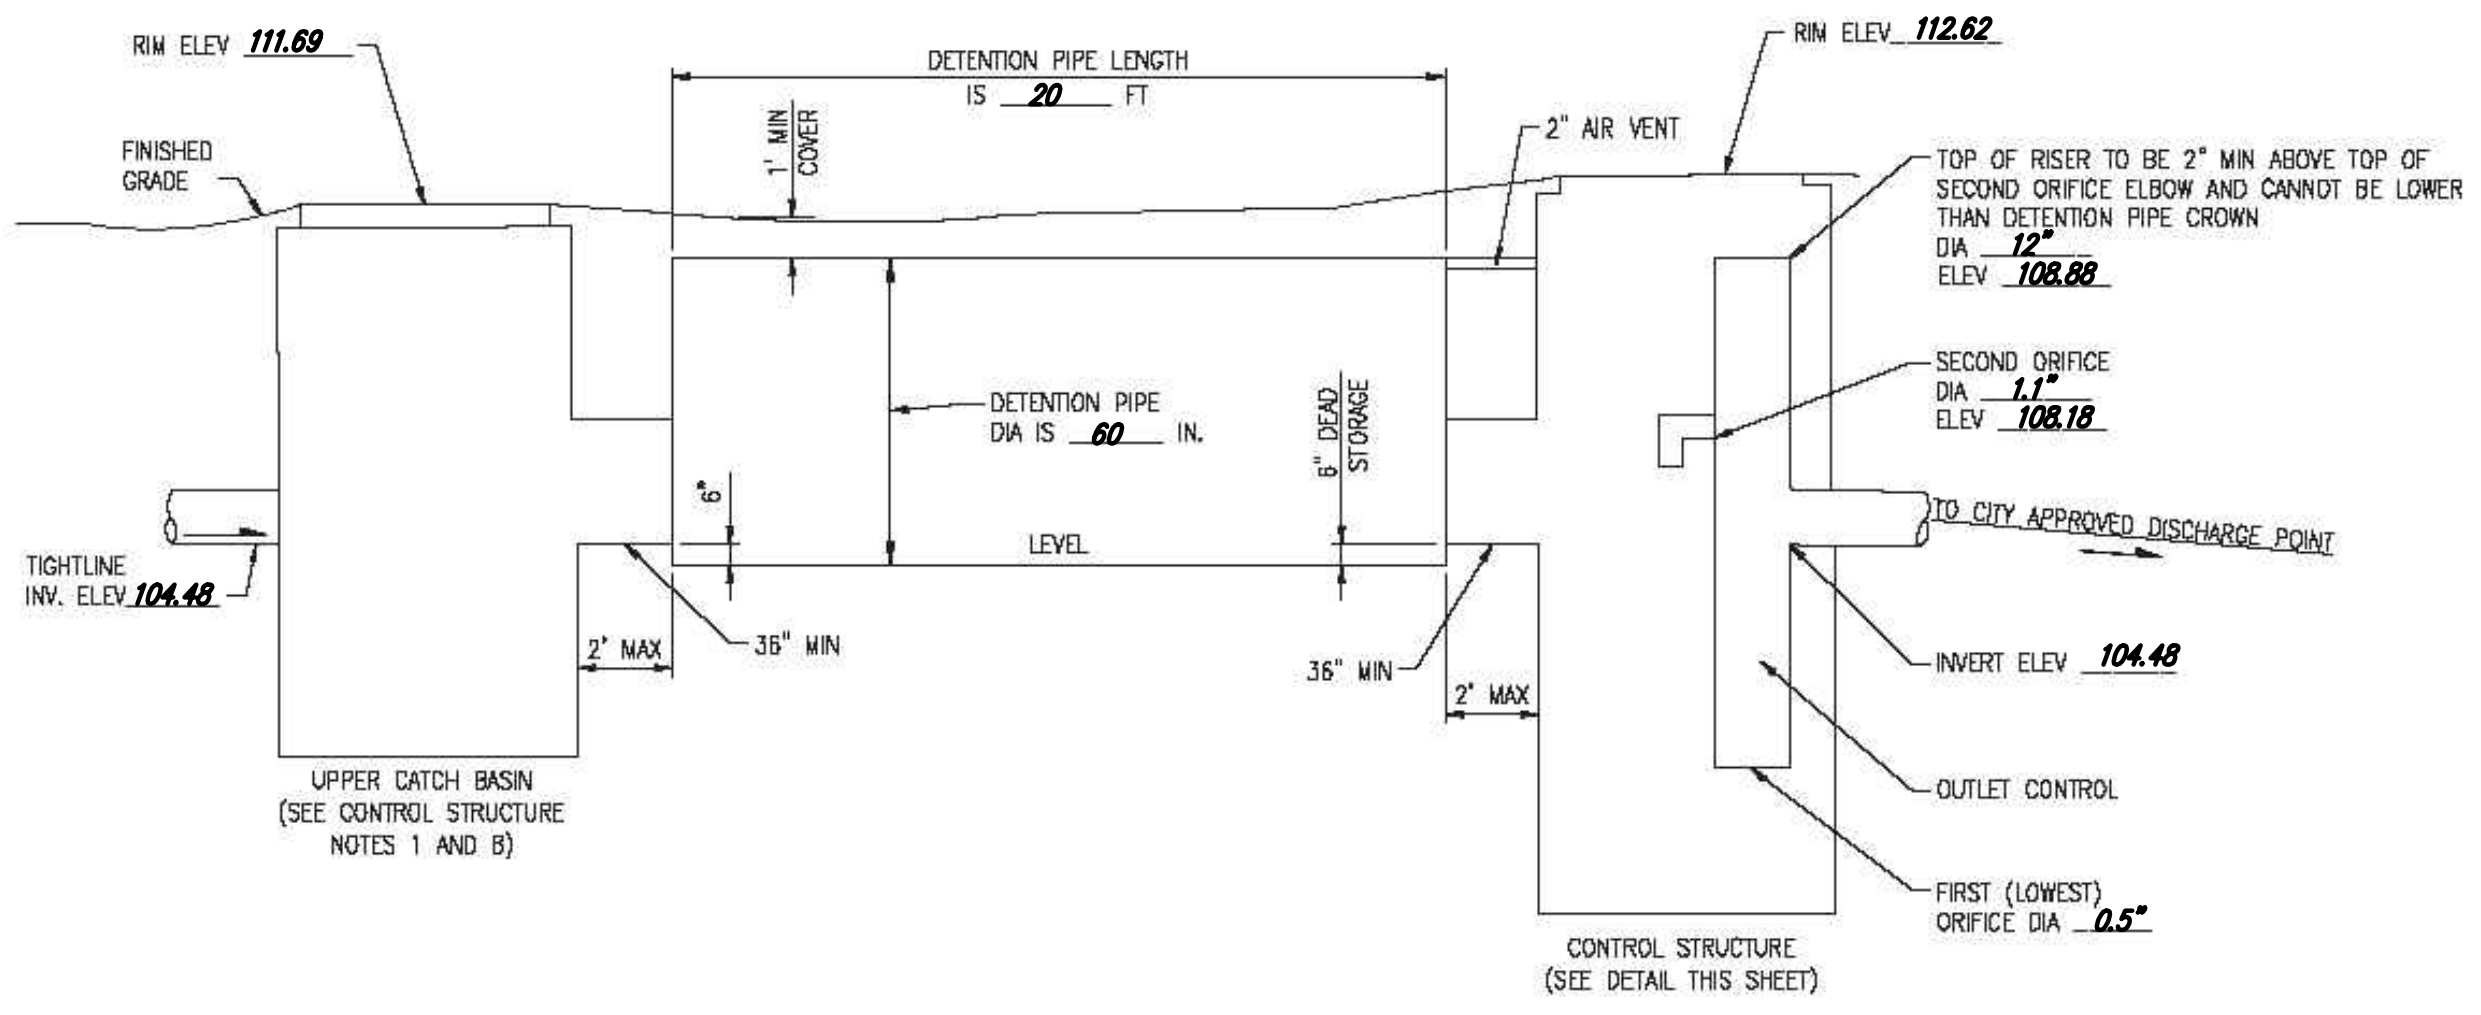

ON-SITE DETENTION SYSTEM
NOT TO SCALE (ENGINEER TO FILL IN BLANKS)


CONTROL STRUCTURE NOTES:

- ① USE A MINIMUM OF A 54 IN. DIAM. TYPE 2 CATCH BASIN. THE ACTUAL SIZE IS DEPENDENT ON CONNECTING PIPE MATERIAL AND DIAMETER.
- ② OUTLET PIPE: MIN. 6 INCH.
- ③ METAL PARTS: CORROSION RESISTANT. NON-GALVANIZED PARTS PREFERRED. GALVANIZED PIPE PARTS TO HAVE ASPHALT TREATMENT.
- ④ FRAME AND LADDER OR STEPS OFFSET SO:
 - A. CLEANOUT GATE IS VISIBLE FROM TOP;
 - B. CLIMB-DOWN SPACE IS CLEAR OF RISER AND CLEANOUT GATE;
 - C. FRAME IS CLEAR OF CURB.
- ⑤ IF METAL OUTLET PIPE CONNECTS TO CEMENT CONCRETE PIPE, OUTLET PIPE TO HAVE SMOOTH O.D. EQUAL TO CONCRETE PIPE I.D. LESS 1/4 IN.
- ⑥ PROVIDE AT LEAST ONE 3 X 0.090 GAUGE SUPPORT BRACKET ANCHORED TO CONCRETE WALL WITH 5/8 IN. STAINLESS STEEL EXPANSION BOLTS OR EMBEDDED SUPPORTS 2 IN. INTO CATCH BASIN WALL (MAXIMUM 3'-0" VERTICAL SPACING).
- ⑦ THE SHEAR GATE SHALL BE MADE OF ALUMINUM ALLOY IN ACCORDANCE WITH ASTM B 26M AND ASTM B 275, DESIGNATION ZG32A; OR CAST IRON IN ACCORDANCE WITH ASTM A 48, CLASS 30B. THE LIFT HANDLE SHALL BE MADE OF A SIMILAR METAL TO THE GATE (TO PREVENT GALVANIC CORROSION). IT MAY BE OF SOLID ROD OR HOLLOW TUBING, WITH ADJUSTABLE HOOK AS REQUIRED. A NEOPRENE RUBBER GASKET IS REQUIRED BETWEEN THE RISER MOUNTING FLANGE AND THE GATE FLANGE. INSTALL THE GATE SO THAT THE LEVEL-LINE MARK IS LEVEL WHEN THE GATE IS CLOSED. THE MATING SURFACES OF THE LID AND THE BODY SHALL BE MACHINED FOR PROPER FIT. ALL SHEAR GATE BOLTS SHALL BE STAINLESS STEEL.
- ⑧ THE UPPER CATCH BASIN IS REQUIRED IF THE LENGTH OF THE DETENTION PIPE IS GREATER THAN 50 FT.

ON-SITE DETENTION SYSTEM NOTES:

1. CALL DEVELOPMENT SERVICES (206-275-7605) 24 HOURS IN ADVANCE FOR A DETENTION SYSTEM INSPECTION BEFORE BACKFILLING AND FOR FINAL INSPECTIONS.
2. RESPONSIBILITY FOR OPERATION AND MAINTANANCE OF DRAINAGE SYSTEMS ON PRIVATE PROPERTY IS RESPONSIBILITY OF THE PROPERTY OWNER. MATERIAL ACCUMULATED IN THE STORAGE PIPE MUST BE REMOVED FROM CATCH BASINS TO ALLOW PROPER OPERATION. THE OUTLET CONTROL ORIFICE MUST BE KEPT OPEN AT ALL TIMES.
3. PIPE MATERIAL, JOINT, AND PROTECTIVE TREATMENT SHALL BE IN ACCORDANCE WITH SECTION 7.04 AND 9.05 OF THE WSDOT STANDARD SPECIFICATION FOR ROAD, BRIDGE, AND MUNICIPAL CONSTRUCTION, LATEST VERSION. SUCH MATERIALS INCLUDE THE FOLLOWING, LINED CORRUGATED POLYETHYLENE PIPE (LCPPE), ALUMINIZED TYPE 2 CORRUGATED STEEL PIPE AND PIPE ARCH (MEETS AASHTO DESIGNATIONS M274 AND M36), CORRUGATED OR SPIRAL RIB ALUMINUM PIPE, OR REINFORCED CONCRETE PIPE. CORRUGATED STEEL PIPE IS NOT ALLOWED.
4. FOOTING DRAINS SHALL NOT BE CONNECTED TO THE DETENTION SYSTEM.

NO.	REVISIONS	DATE

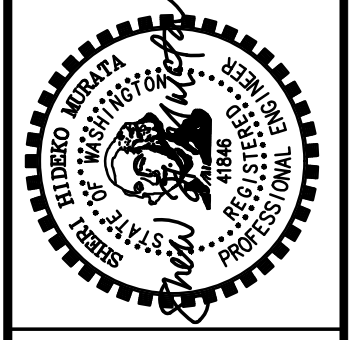

CIVIL ENGINEERING
LANDSCAPE ARCHITECTURE
PLANNING
SURVEYING



STORMWATER DETAILS
CHESHIRE SHORT PLAT LOT 1
DEREK CHESHIRE
7615 E MERCER WAY
MERCER ISLAND, WA 98040

DATE: JULY 2020 (IST SUB)
DESIGNED: SHERI MURATA, P.E.
DRAWN: SAM D. SIMPSON-GORDON
APPROVED: SHERI MURATA, P.E.
ROBERT WEST, PLS
PROJECT MANAGER


SHEET	OF
4	5
PROJECT NUMBER	
19205	

UNDERGROUND LOCATOR SERVICE
CALL BEFORE YOU DIG!
811

PERMIT NO: 2021-XXX

9/2/2021 8:03 AM J:\2019\19205\ENGINEERING\FINAL\SHEETS\19205_C3-31.DWG

7-27-2021

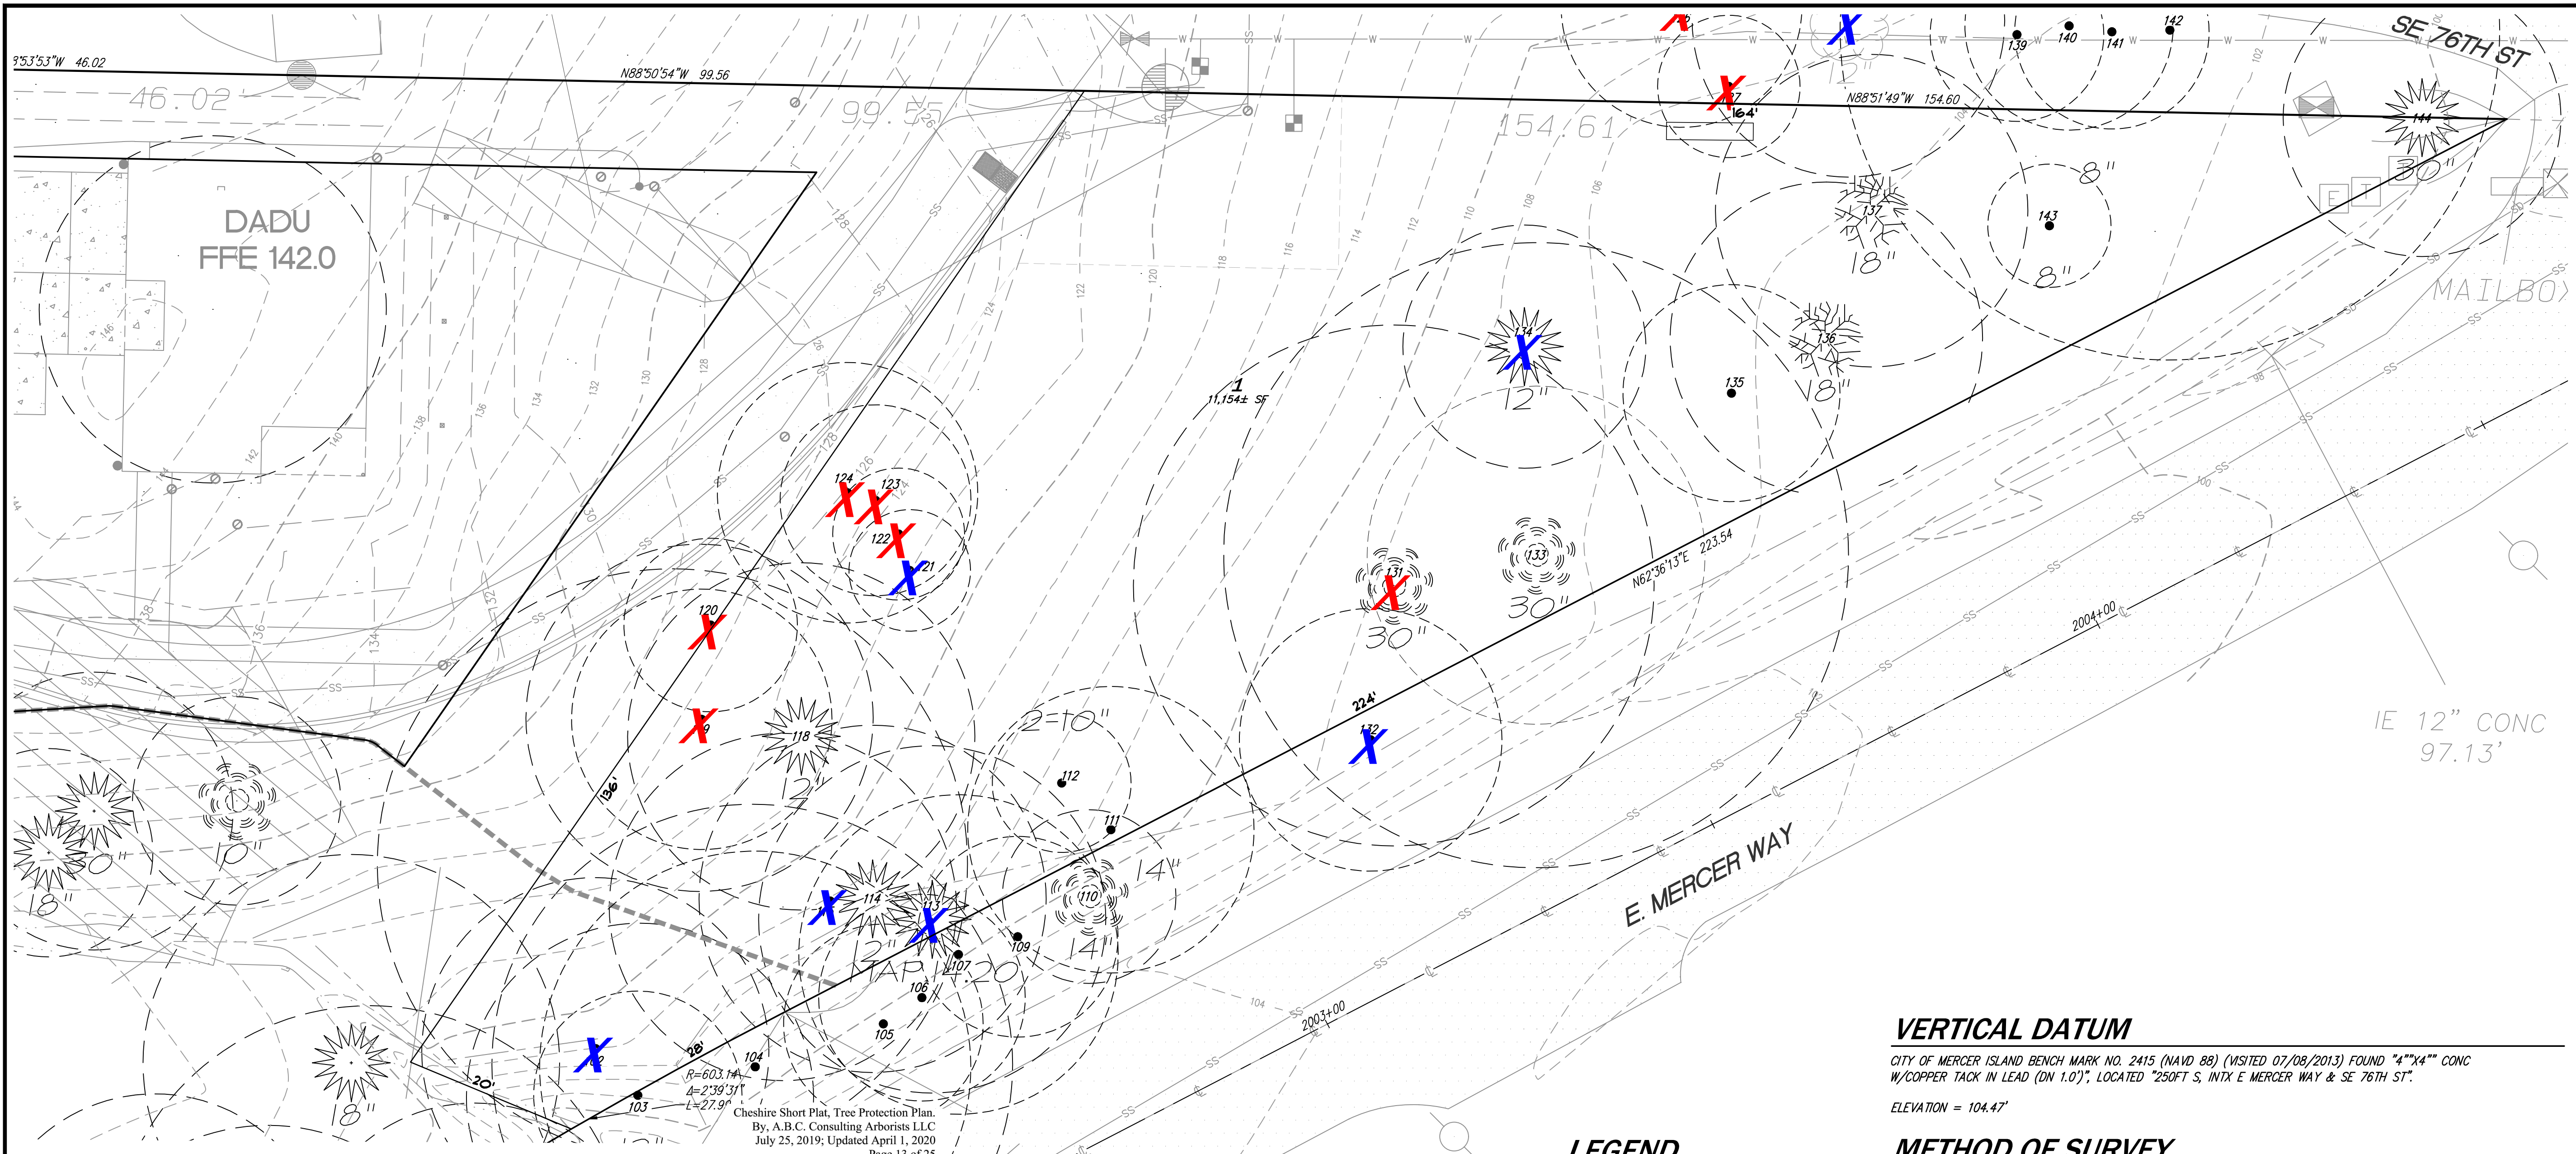

Cheshire Short Plat, Tree Protection Plan.
By: A.B.C. Consulting Arborists LLC
July 25, 2019; Updated April 1, 2020
Page 13 of 25

ATTACHMENT 2 - TREE SUMMARY, TPZ, CRZ

ID	Common	Latin	DBH	Height	Spread	Condition	Action	TPZ - [ft]	CRZ - [ft]	Notes
103	Maple	<i>Acer macrophyllum</i>	12	68	17	Fair (70+)	Retain-Viable	12	6	
104	Maple	<i>Acer macrophyllum</i>	24.84	75	23	Good (80+)	Retain-Viable	24.84	12.42	
105	Maple	<i>Acer macrophyllum</i>	11.5	65	20	Fair (70+)	Retain-Viable	11.5	5.75	
106	Maple	<i>Acer macrophyllum</i>	11.9	50	28	Poor (50+)	Retain-Viable	11.9	5.95	Suppressed
107	Maple	<i>Acer macrophyllum</i>	18.4	68	40	Fair (70+)	Retain-Viable	18.4	9.2	
109	Maple	<i>Acer macrophyllum</i>	11.56	55	21	Fair (70+)	Retain-Viable	11.56	5.78	
110	Maple	<i>Acer macrophyllum</i>	13.93	50	28	Fair (70+)	Retain-Viable	13.93	6.965	
111	Cedar	<i>Thuja plicata</i>	16.5	50	26	Good (80+)	Retain-Viable	16.5	8.25	
112	Maple	<i>Acer macrophyllum</i>	8	50	12	Fair (70+)	Retain-Viable	8	4	
113	Maple	<i>Acer macrophyllum</i>	16	72	20	Very Poor (25+)	Not Viable	16	8	Mostly dead, not long-term viable
114	Maple	<i>Acer macrophyllum</i>	14.5	72	28	Poor (50+)	Retain-Viable	14.5	7.25	
115	Maple	<i>Acer macrophyllum</i>	15	50	20	Very Poor (25+)	Not Viable	15	7.5	Extensive root decay.
118	Cedar	<i>Thuja plicata</i>	6.2	29	18	Good (80+)	Retain-Viable	6.2	3.1	
119	Maple	<i>Acer macrophyllum</i>	15	68	18	Fair (70+)	Conflicts with plans	15	7.5	Poor taper/LCR,
120	Maple	<i>Acer macrophyllum</i>	10	48	18	Fair (70+)	Conflicts with plans	10	5	
121	Cedar	<i>Thuja plicata</i>	7	28	15	Poor (50+)	Not Viable	7	3.5	Previously uprooted
122	Cedar	<i>Thuja plicata</i>	7.6	30	15	Fair (70+)	Conflicts with plans	7.6	3.8	
123	Cedar	<i>Thuja plicata</i>	11	42	26	Good (80+)	Conflicts with plans	11	5.5	
124	Cedar	<i>Thuja plicata</i>	15	45	22	Fair (70+)	Conflicts with plans	15	7.5	
126	Maple	<i>Acer macrophyllum</i>	13.87	50	34	Good (80+)	Conflicts with plans	13.87	6.935	
127	W. Pine	<i>Pinus monticola</i>	8.2	48	18	Good (80+)	Conflicts with plans	8.2	4.1	
131	Redwood	<i>Sequoia sempervirens</i>	28	98	35	Excellent (90+)	Conflicts with plans	21	10.5	
132	Alder	<i>Alnus rubra</i>	12.1	50	0	Dead (0)	Not Viable	15.125	7.5625	
133	Cedar	<i>Thuja plicata</i>	36	90	24	Excellent (90+)	Retain-Viable	36	18	
134	Maple	<i>Acer macrophyllum</i>	13	40	29	Poor (50+)	Not Viable	13	6.5	Suppressed/bowed crown/ not viable
135	Cherry	<i>Prunus ssp.</i>	10	45	22	Fair (70+)	Retain-Poor cond.	12.5	6.25	
136	Cedar	<i>Thuja plicata</i>	11.1	40	22	Good (80+)	Retain-Viable	11.1	5.55	
137	Fir	<i>Pseudotsuga menziesii</i>	22	98	30	Good (80+)	Retain-Viable	22	11	
138	Alder	<i>Alnus rubra</i>	16	50	26	Fair (70+)	Not Viable	20	10	Top 1/2 is dead.
139	Cedar	<i>Thuja plicata</i>	10	34	15	Good (80+)	Retain-Viable	10	5	
140	Cedar	<i>Thuja plicata</i>	12	45	25	Good (80+)	Retain-Viable	12	6	
141	Cedar	<i>Thuja plicata</i>	11.2	45	25	Good (80+)	Retain-Viable	11.2	5.6	
142	Maple	<i>Acer macrophyllum</i>	38	25	25	Very Poor (25+)	Retain-Viable	38	19	Tree has been topped @ 20ft TM . Monitor and mitigation prune as needed
143	Cedar	<i>Thuja plicata</i>	7.1	40	25	Good (80+)	Retain-Viable	7.1	3.55	
144	Maple	<i>Acer macrophyllum</i>	24	55	25	Fair (70+)	Retain-Viable	24	12	

I made a field examination of Tree 133. It is viable to set the TPZ at 18-feet. Arborist Shall oversee Excavation and Prune Roots as needed. An Application of Cambistat 3-months Prior to construction and 4-inches of Mulch in the CRZ would be beneficial.

LEGEND

- X TREE NOT VIABLE
- X TREE TO BE REMOVED

VERTICAL DATUM

CITY OF MERCER ISLAND BENCH MARK NO. 2415 (NAVD 88) (VISITED 07/08/2013) FOUND "4"x4" CONC W/COPPER TACK IN LEAD (DN 1.0)", LOCATED "250FT S, INTX E MERCER WAY & SE 76TH ST".
ELEVATION = 104.47'

METHOD OF SURVEY

INSTRUMENTATION FOR THIS SURVEY WAS A LEICA ELECTRONIC DISTANCE MEASURING UNIT. PROCEDURES USED IN THIS SURVEY WERE DIRECT AND REVERSE ANGLES, NO CORRECTION NECESSARY. MEETS STATE STANDARDS SET BY WAC 332-130-090.

BEARING MERIDIAN

A BEARING OF S50°21'13"W BETWEEN TWO FOUND MONUMENTS, "A" AND "B", PER THE PLAT OF TARYWOOD PARK, AS RECORDED IN VOLUME 127 OF PLATS, PAGES 46-50, RECORDS OF KING COUNTY, WA.


LEGAL DESCRIPTION

NORTH 148.375 FEET OF GOVERNMENT LOT 6; EXCEPT THE WEST 1000 FEET ALSO THE NORTH 148.37 FEET OF A PORTION OF GOVERNMENT LOT 5 LYING WESTERLY OF EAST MERCER WAY; ALL IN SECTION 30, TOWNSHIP 24 NORTH, RANGE 5 EAST, W.M. IN KING COUNTY, WASHINGTON.

SURVEYOR'S NOTES

- THE TOPOGRAPHIC SURVEY SHOWN HEREON WAS PERFORMED IN JULY OF 2013. THE FIELD DATA WAS COLLECTED AND RECORDED ON MAGNETIC MEDIA THROUGH AN ELECTRONIC THEODOLITE. THE DATA FILE IS ARCHIVED ON DISC OR CD. WRITTEN FIELD NOTES MAY NOT EXIST. CONTOURS ARE SHOWN FOR CONVENIENCE ONLY. DESIGN SHOULD RELY ON SPOT ELEVATIONS.
- SUBJECT PROPERTY TAX PARCEL NO. 3024059036.
- SUBJECT PROPERTY AREA PER THIS SURVEY IS 88,557 SQ.FT. +/-.
- A TITLE REPORT WAS NOT FURNISHED AND THEREFORE, EASEMENTS IF ANY, ARE NOT SHOWN ON THIS MAP.
- THE TOP/TOE OF SLOPE SHOWN ON THIS SURVEY IS THE FIELD CREWS INTERPRETATION OF THE TOP/TOE OF SLOPE. THIS DOES NOT REPRESENT THE LIMITS OF A "40%" SLOPE AREA.

SCALE: 1" = 10'

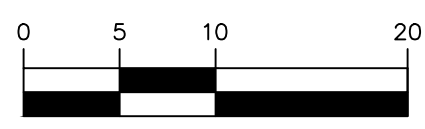

UNDERGROUND LOCATOR SERVICE
CALL BEFORE YOU DIG!
811

DATE	JULY 2020 (1ST SUB)
DESIGNED	SHERI MURATA, P.E.
DRAWN	SAM D. SIMPSON-GORDON
APPROVED	SHERI MURATA, P.E.
PROJECT MANAGER	ROBERT WEST, PLS
SHEET	5
OF	5
PROJECT NUMBER	19205

TREE PLAN
CHESHIRE SHORT PLAT LOT 1
DEREK CHESHIRE
7615 E MERCER WAY
MERCER ISLAND, WA 98040

CORE DESIGN
CIVIL ENGINEERING
LANDSCAPE ARCHITECTURE
PLANNING
SURVEYING
12100 NE 195th St, Suite 300 Bothell, Washington 98011 425.885.7877

7-27-2021



1 TREE PLANTING PLAN
SCALE: 1:10

TREE REPLACEMENT

Tree replacement- removed trees must be replaced based on the ratio in the table below. Replacement trees shall be conifers at least six feet tall and or deciduous at least one and one-half inches in diameter at base.

Diameter of Removed Tree (measured 4.5' above ground)	Tree replacement Ratio	Number of Trees Proposed for Removal	Number of Tree Required for Replacement Based on Size/Type
*Less than 10"	1 Exempt	3	0
Tree 132 (Dead) in ROW	1 at 1:1	1	1
10" up to 24"	2:1	5	10
Greater than 24" up to 36"	3:1	1	3
Greater than 36" and any Exceptional Tree	6:1	0	0
TOTAL TREE REPLACEMENTS			14

*PER ARBORIST REPORT DATED JULY 25TH 2019

TREE REPLACEMENT SCHEDULE

SYMBOL	NAME	SPACING	QUANTITY
	VINE MAPLE	10'	7
	ACER CIRCINATUM		
	MOUNTAIN HEMLOCK	10'	4
	TSUGA MERTENSIANA		
	PACIFIC DOGWOOD	10'	3
	CORNUS NUTTALLII		
	TOTAL		14

REMOVE ALL INVASIVES FROM SITE. PLANTING SHOULD BE DONE OCTOBER 1 - APRIL 1. FALL PLANTINGS ARE PREFERRED. FOR 2 YR-BEARS MAY - SEPTEMBER MONITOR PLANTS/SOILS FOR MOISTURE WEEKLY. SUPPLEMENTAL WATER AS NEEDED. FOR 3 YEARS MONITOR AND WEED AS NEEDED TO CONTROL WEEDS (PROPER MULCHING SHOULD REDUCE THE NEED TO WEED)

Page 13 of 25

ATTACHMENT 2 - TREE SUMMARY, TPZ, CRZ




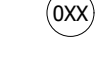
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133	Cedar	<i>Thuja plicata</i>	36	90	24	Excellent (90+)	Retain-Viable	36	18	
134	Maple	<i>Acer macrophyllum</i>	13	40	29	Poor (50+)	Not Viable	13	6.5	Suppressed /bowed crown/ not viable
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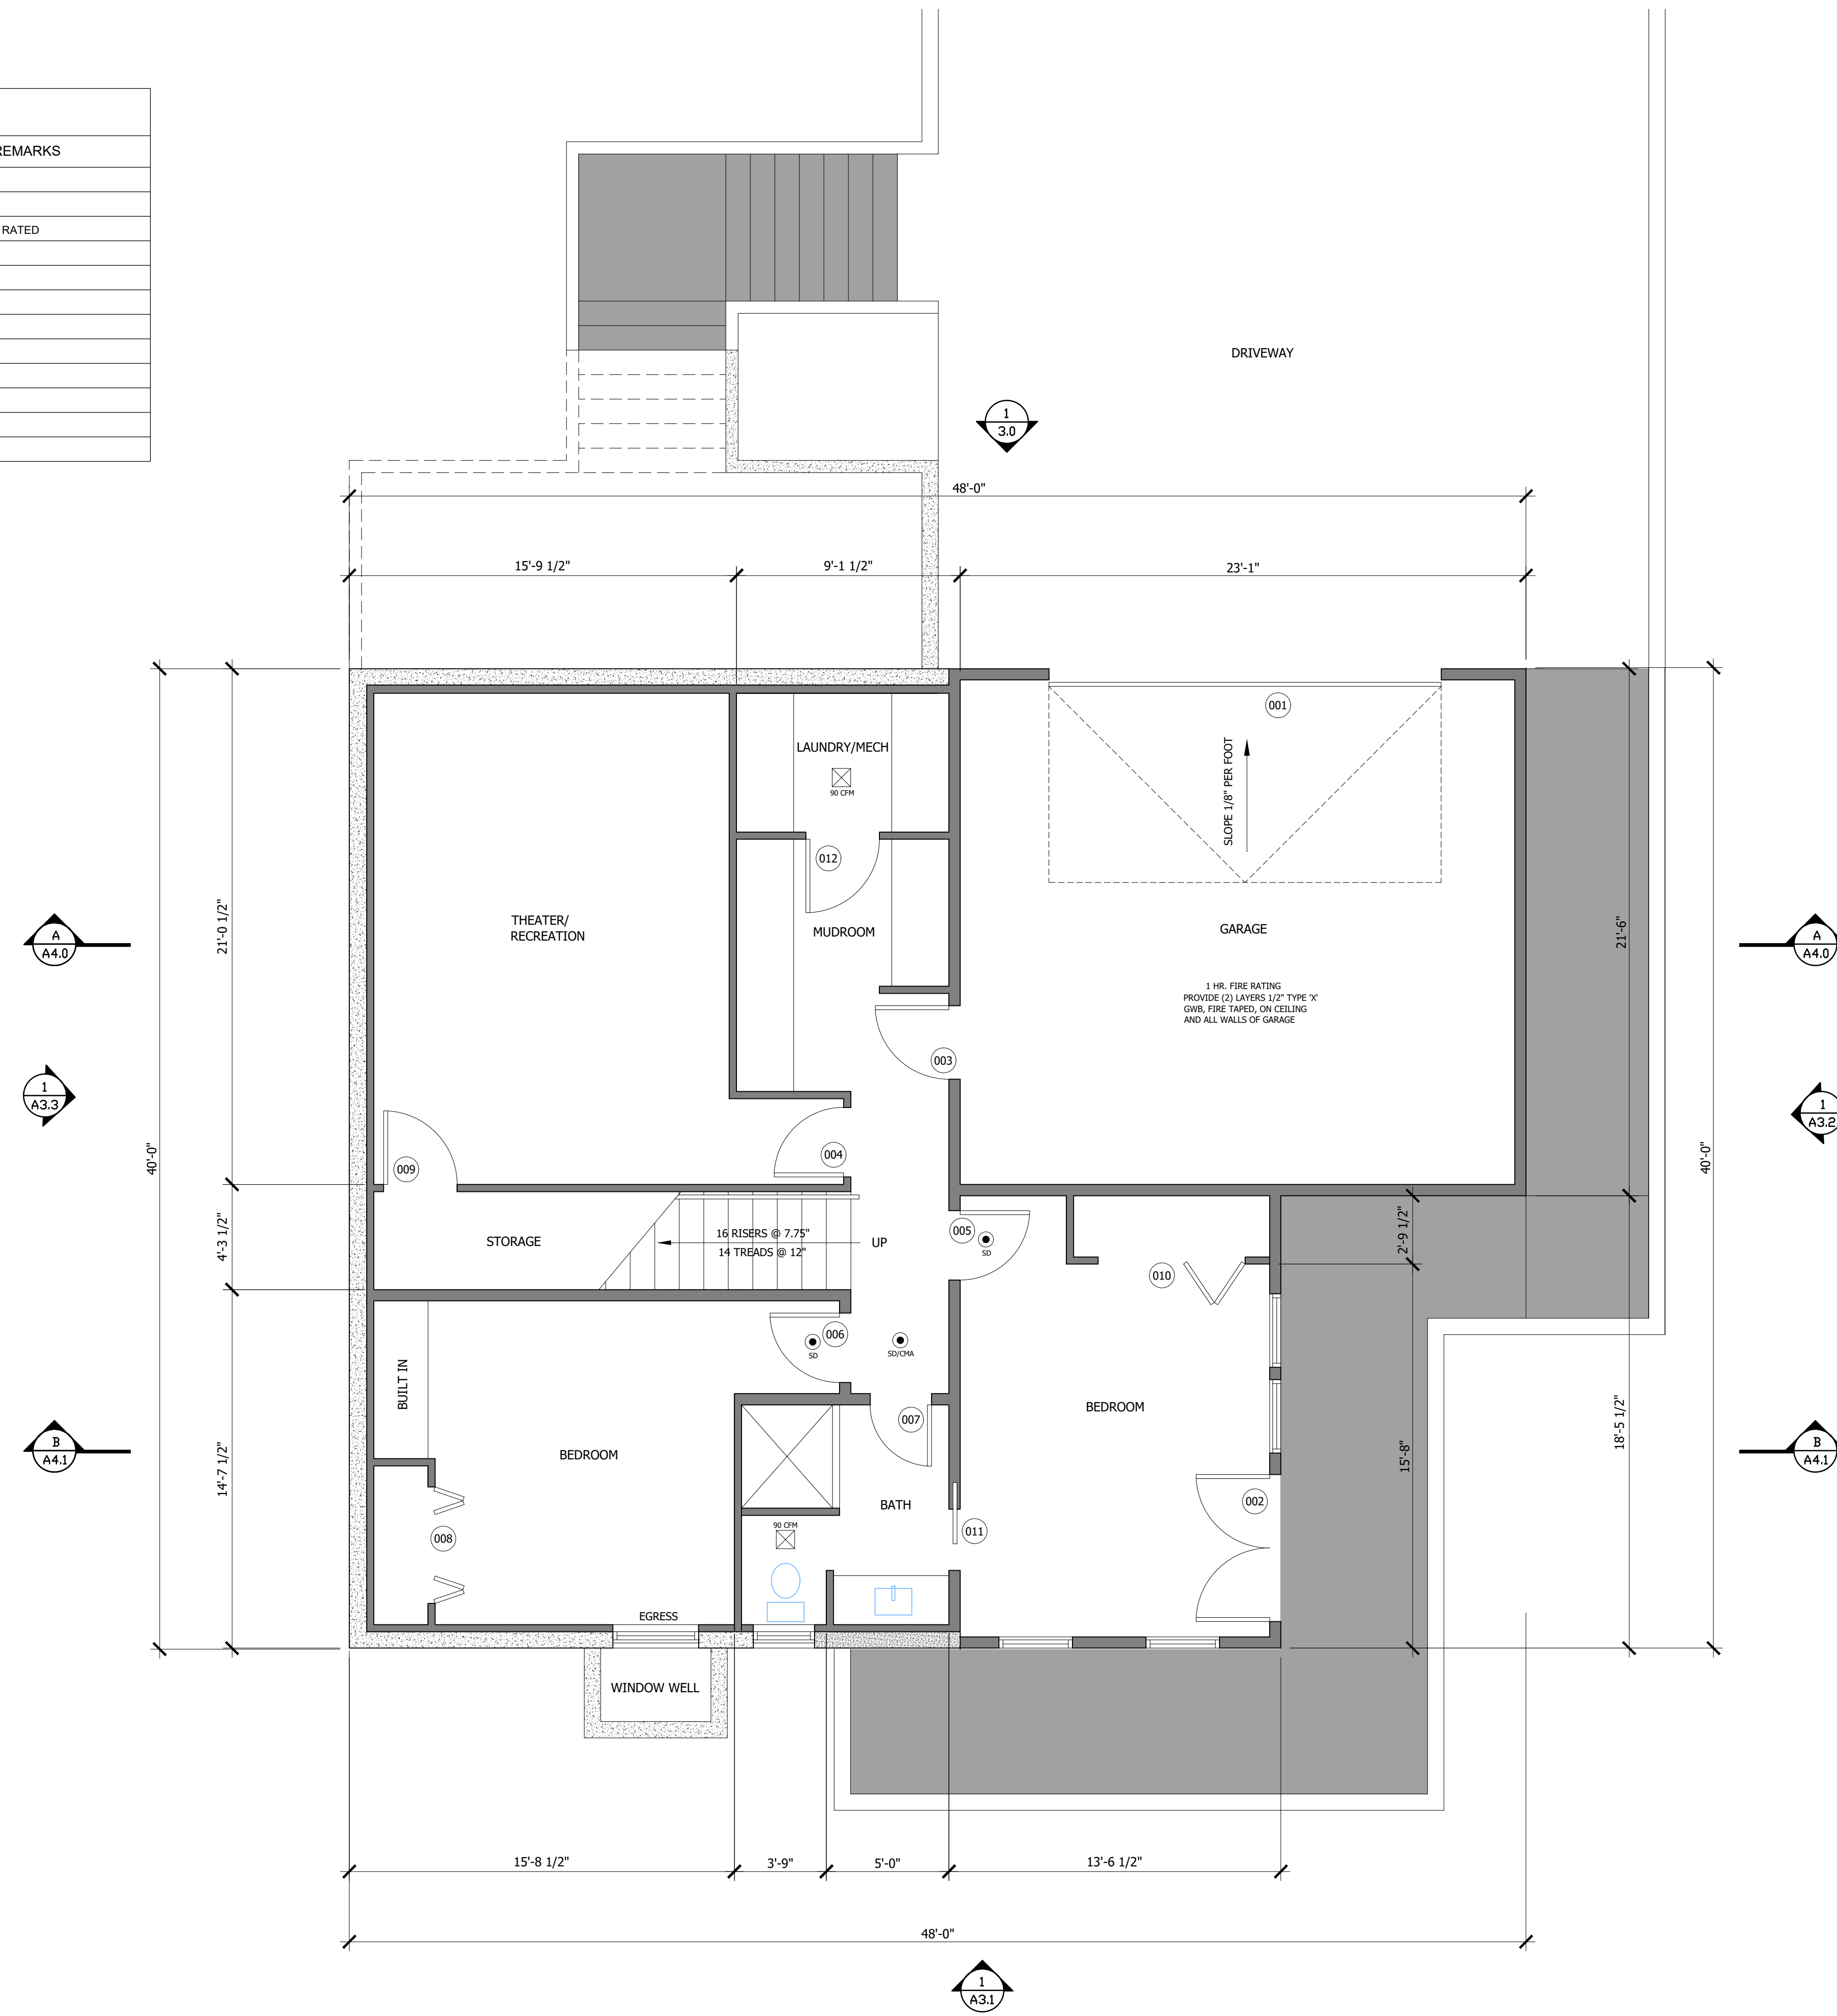
I Made a field examination of Tree 133. It is viable to set the TPZ at 18-feet. Arborist Shall oversee Excavation and Prune Roots as needed. An Application of Cambistat 3-months Prior to construction and 4-inches of Mulch in the CRZ would be beneficial.

LOWER FLOOR DOOR SCHEDULE

MARK	R.O. SIZE	TYPE	THICK	REMARKS
001	8'0 X 16'0	OVERHEAD GARAGE DOOR	1-3/4"	
002	6'0 X 7'0	EXTERIOR FRENCH DOORS	1-3/8"	GLAZED
003	3'0 X 7'0	SOLID CORE FLUSH	1-3/4"	1 HOUR FIRE RATED
004	2'10 X 7'0	SOLID CORE FLUSH	1-3/8"	
005	2'10 X 7'0	SOLID CORE FLUSH	1-3/8"	
006	2'10 X 7'0	SOLID CORE FLUSH	1-3/8"	
007	2'6 X 7'0	SOLID CORE FLUSH	1-3/8"	
008	5'0 X 7'0	SOLID CORE BI-FOLD DOORS	1-3/8"	
009	3'0 X 7'0	SOLID CORE FLUSH	1-3/8"	
010	6'0 X 7'0	SOLID CORE BI-FOLD DOORS	1-3/8"	
011	2'6 X 7'0	SOLID CORE FLUSH	1-3/8"	
012	3'0 X 7'0	SOLID CORE FLUSH	1-3/8"	

PLAN KEY

-  COMBINED SMOKE/CARBON MONOXIDE ALARM
-  SMOKE DETECTOR
-  EXHAUST VENTILATION FAN
-  DOOR TAG




1 LOWER LEVEL PLAN
SCALE: 1/4" = 1'

MAIN FLOOR DOOR SCHEDULE

MARK	R.O. SIZE	TYPE	THICK	REMARKS
100	3'6" X 8'0"	EXTERIOR ENTRY DOOR	1-3/4"	GLAZED, TEMPERED
101	1'10" X 8'0"	NANOWALL	1-3/4"	GLAZED, TEMPERED
102	6'0" X 8'0"	EXTERIOR FRENCH DOORS	1-3/4"	GLAZED, TEMPERED
103	2'6" X 8'0"	SOLID CORE FLUSH	1-3/8"	
104	4'0" X 8'0"	SOLID CORE BI-FOLD DOOR	1-3/8"	
105	2'6" X 8'0"	SOLID CORE FLUSH	1-3/8"	
106	4'0" X 8'0"	POCKET DOOR	1-3/8"	
107	4'0" X 8'0"	POCKET DOOR	1-3/8"	

PLAN KEY

- COMBINED SMOKE/CARBON MONOXIDE ALARM
- SMOKE DETECTOR
- EXHAUST VENTILATION FAN
- DOOR TAG

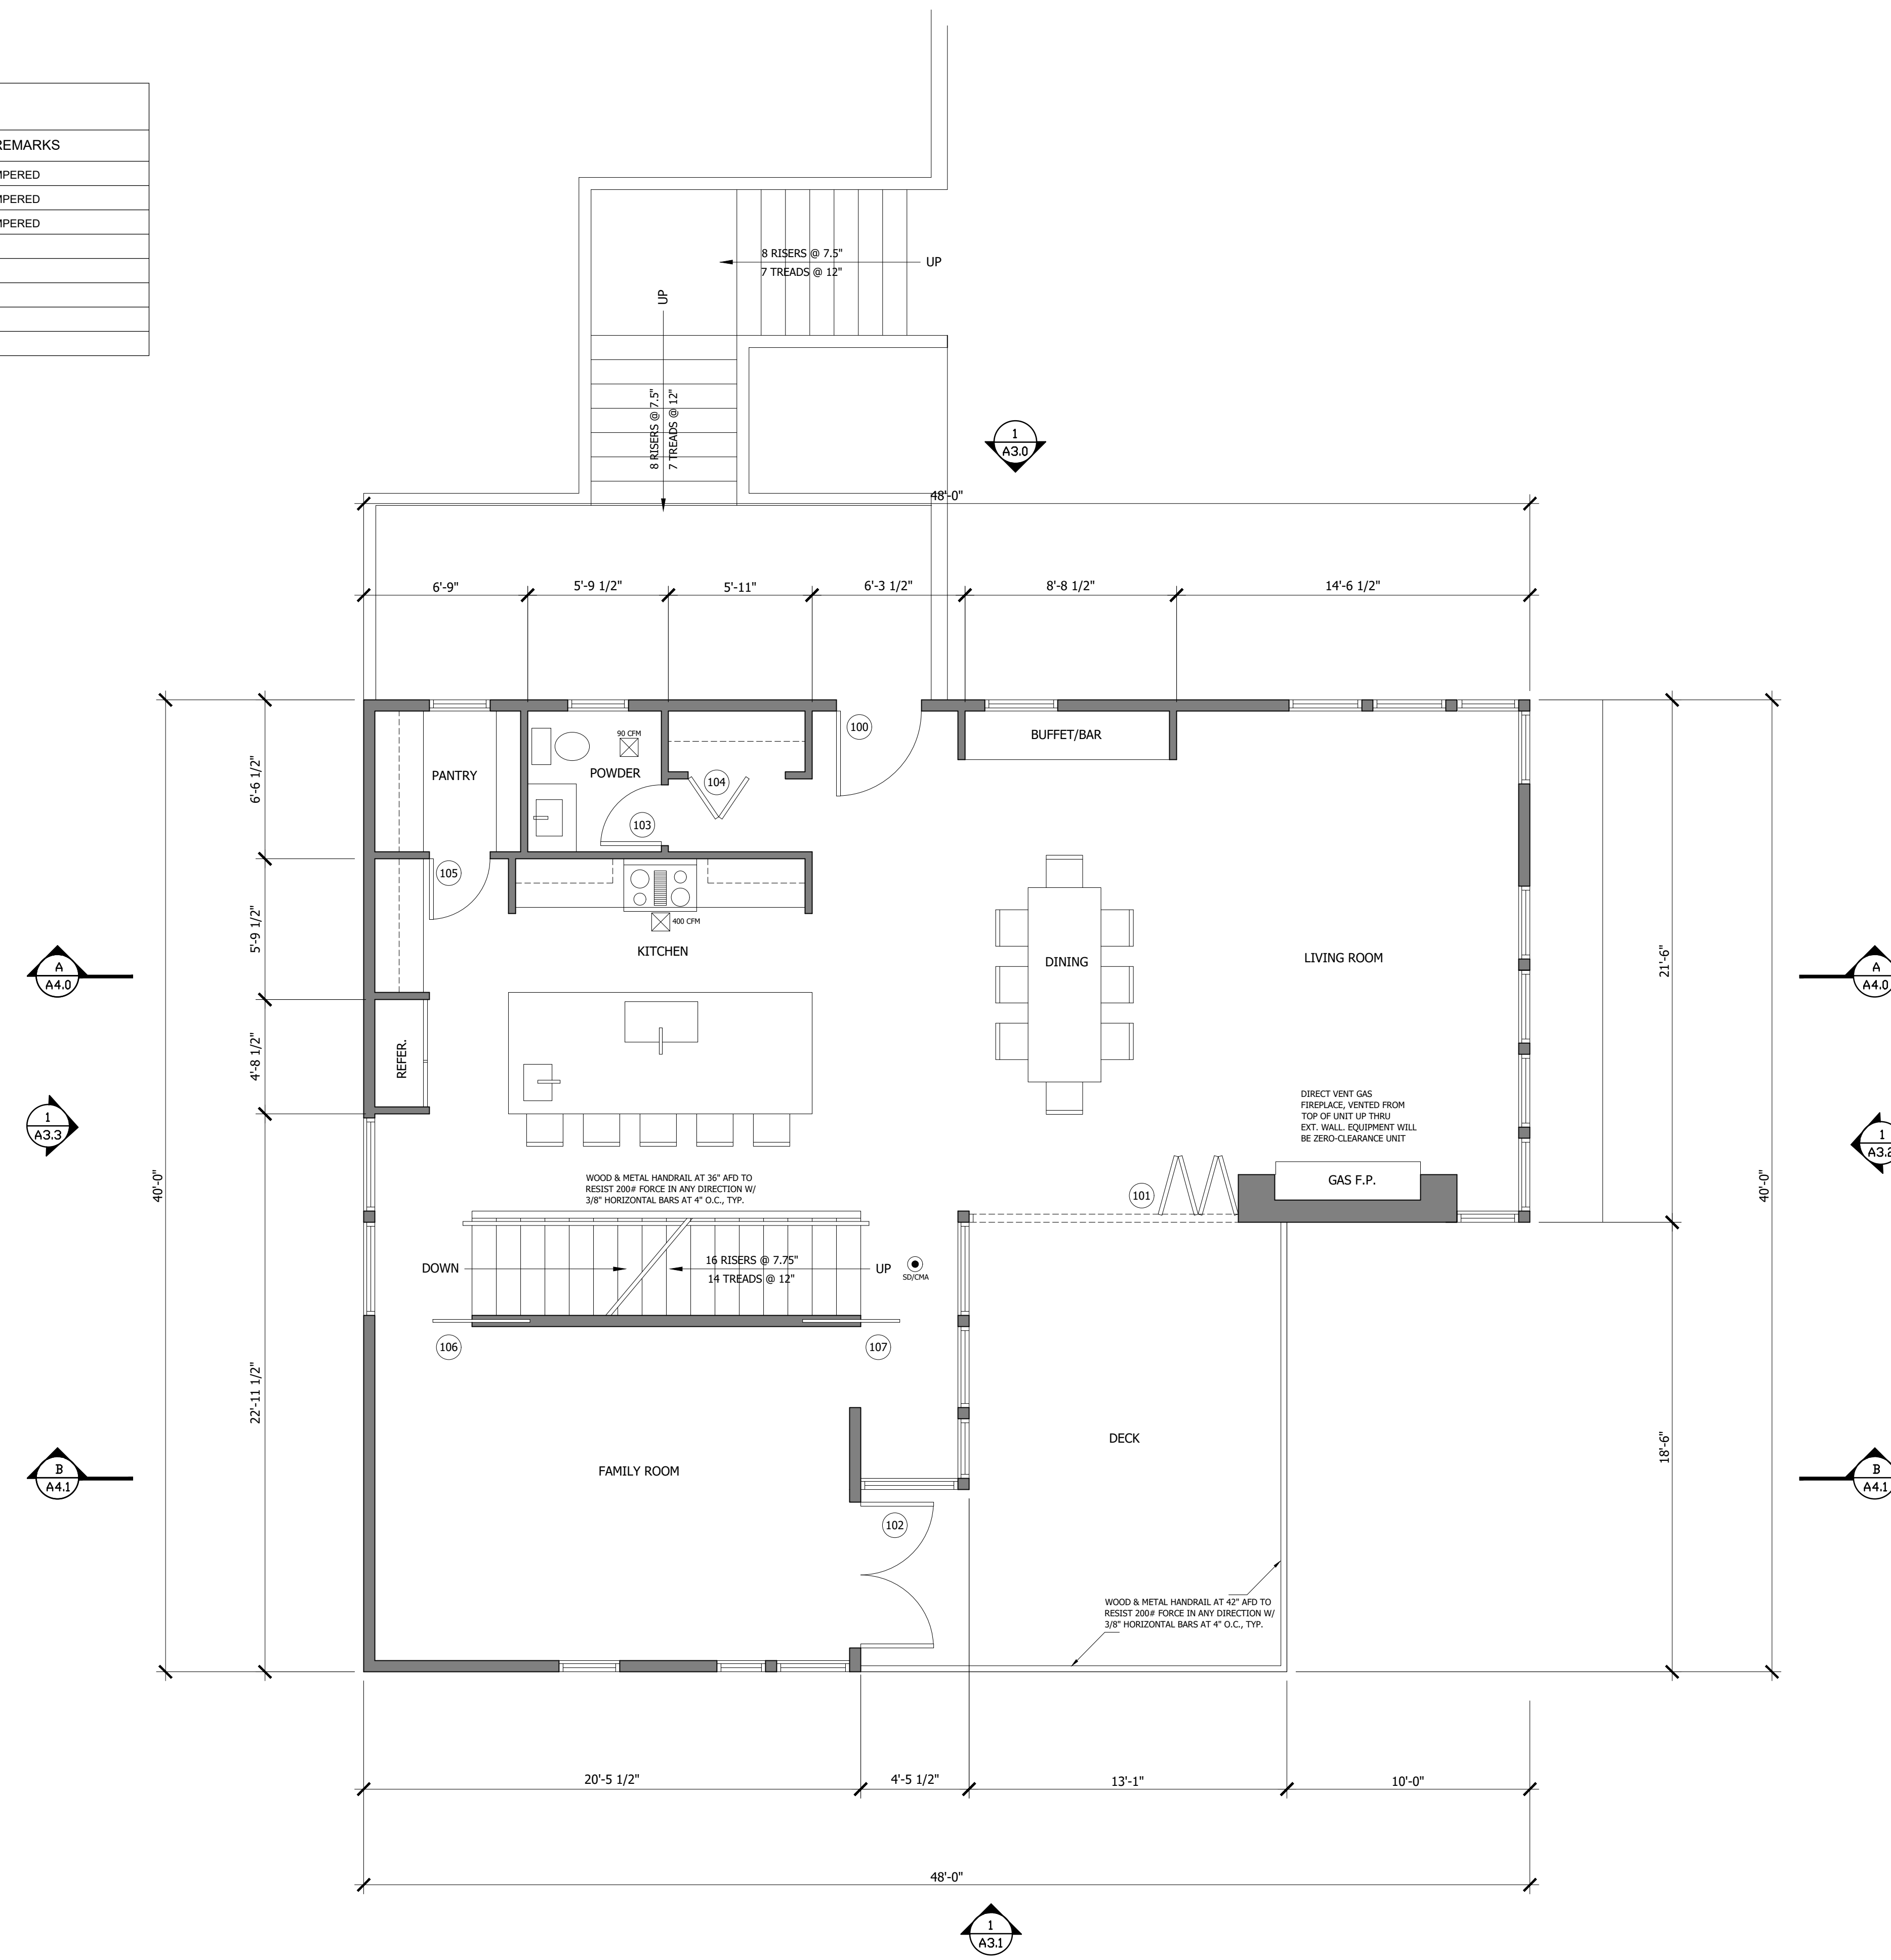


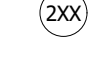



1 MAIN FLOOR PLAN
 SCALE: 1/4" = 1'


SECOND FLOOR DOOR SCHEDULE


MARK	R.O. SIZE	TYPE	THICK	REMARKS
200	3'0 X 7'0	SOLID CORE FLUSH	1-3/8"	
201	2'10 X 7'0	SOLID CORE FLUSH	1-3/8"	
202	2'10 X 7'0	SOLID CORE FLUSH	1-3/4"	
203	2'6 X 7'0	SOLID CORE FLUSH	1-3/8"	
204	2'6 X 7'0	SOLID CORE FLUSH	1-3/8"	
205	2'6 X 7'0	SOLID CORE FLUSH	1-3/8"	
206	4'0 X 7'0	POCKET DOOR	1-3/8"	
207	3'0 X 7'0	POCKET DOOR	1-3/8"	
208	2'6 X 7'0	POCKET DOOR	1-3/8"	
209	5'0 X 7'0	SOLID CORE BI-FOLD CLOSET	1-3/8"	
210	10'0 X 8'0	NANOWALL		GLAZED, TEMPERED

PLAN KEY

-  COMBINED SMOKE/CARBON MONOXIDE ALARM
-  SMOKE DETECTOR
-  EXHAUST VENTILATION FAN
-  DOOR TAG

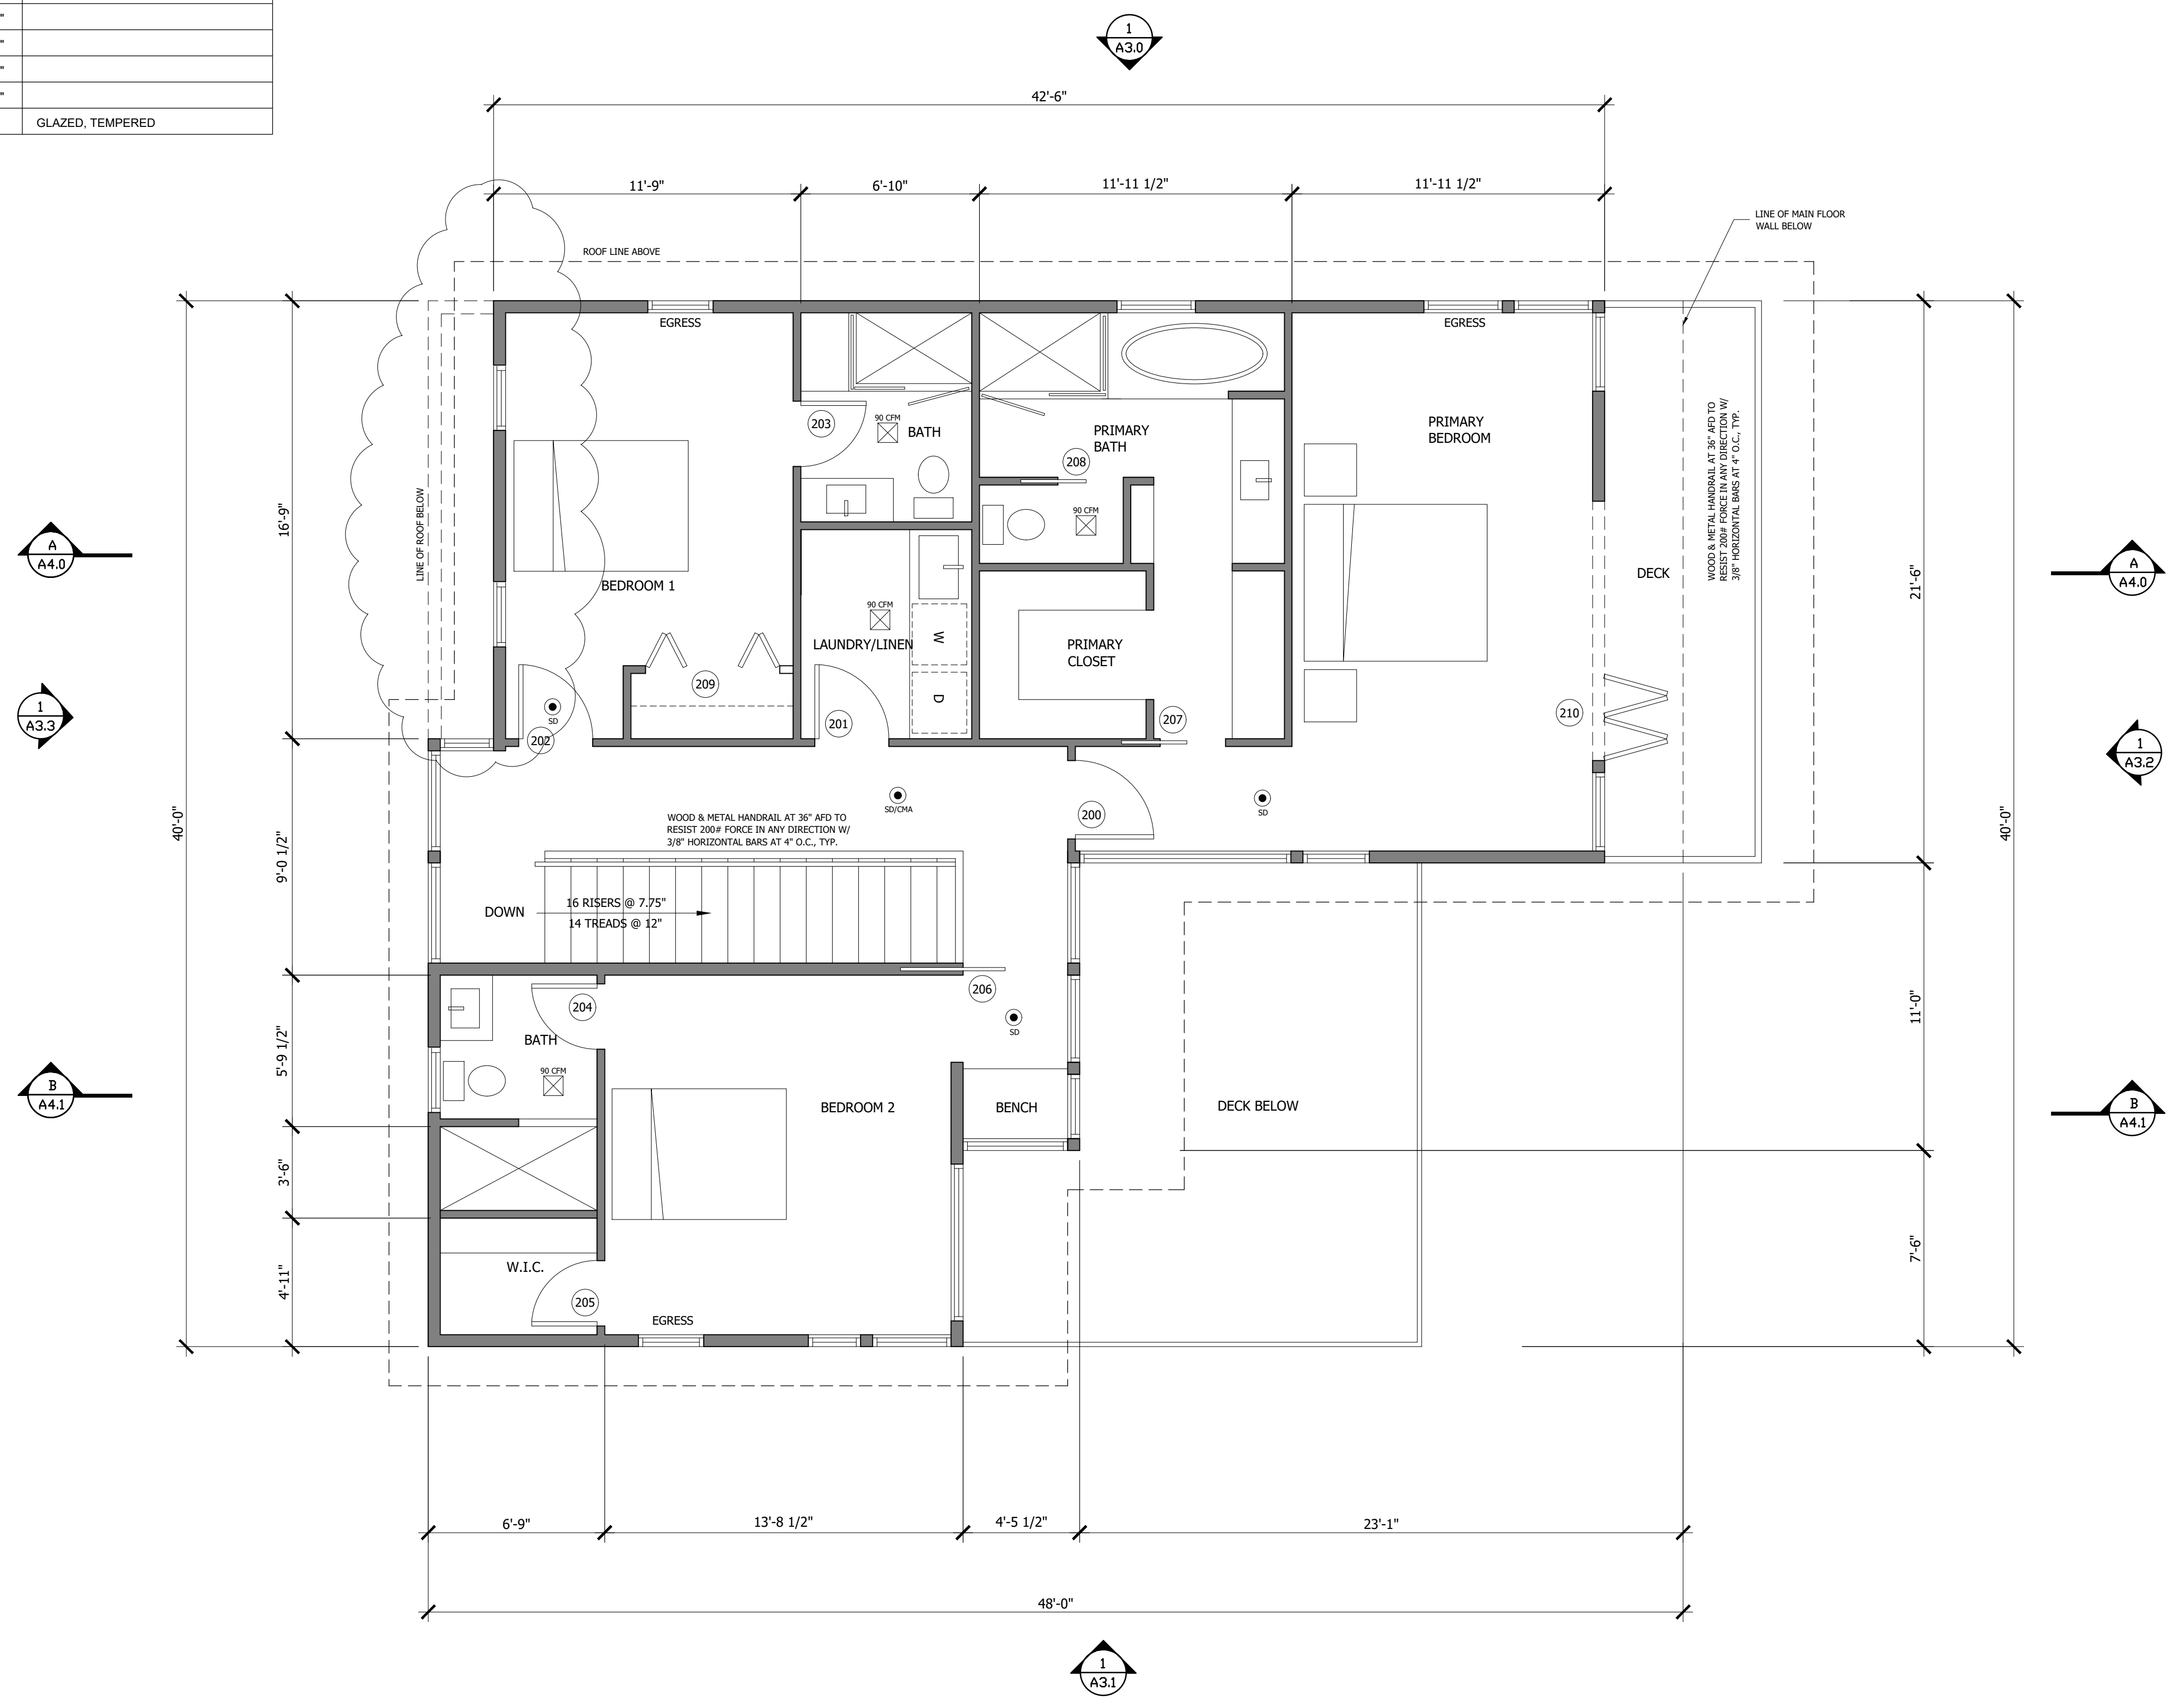


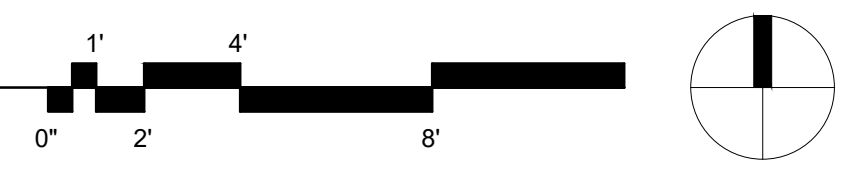2 UPPER LEVEL PLAN
 SCALE: 1/4" = 1'

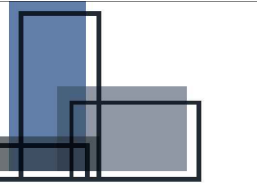


FORMWORKS
DESIGN | BUILD

SEAL

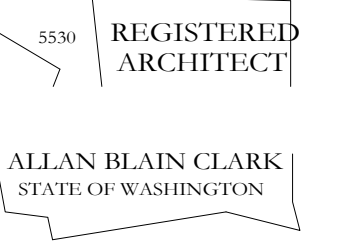

CONSULTANT

PROJECT

CHESHIRE

92XX SE 76TH STREET
MERCER ISLAND, WA 98040

ISSUE INFORMATION


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SHEET TITLE

ROOF PLAN


SHEET NUMBER

A-2.3

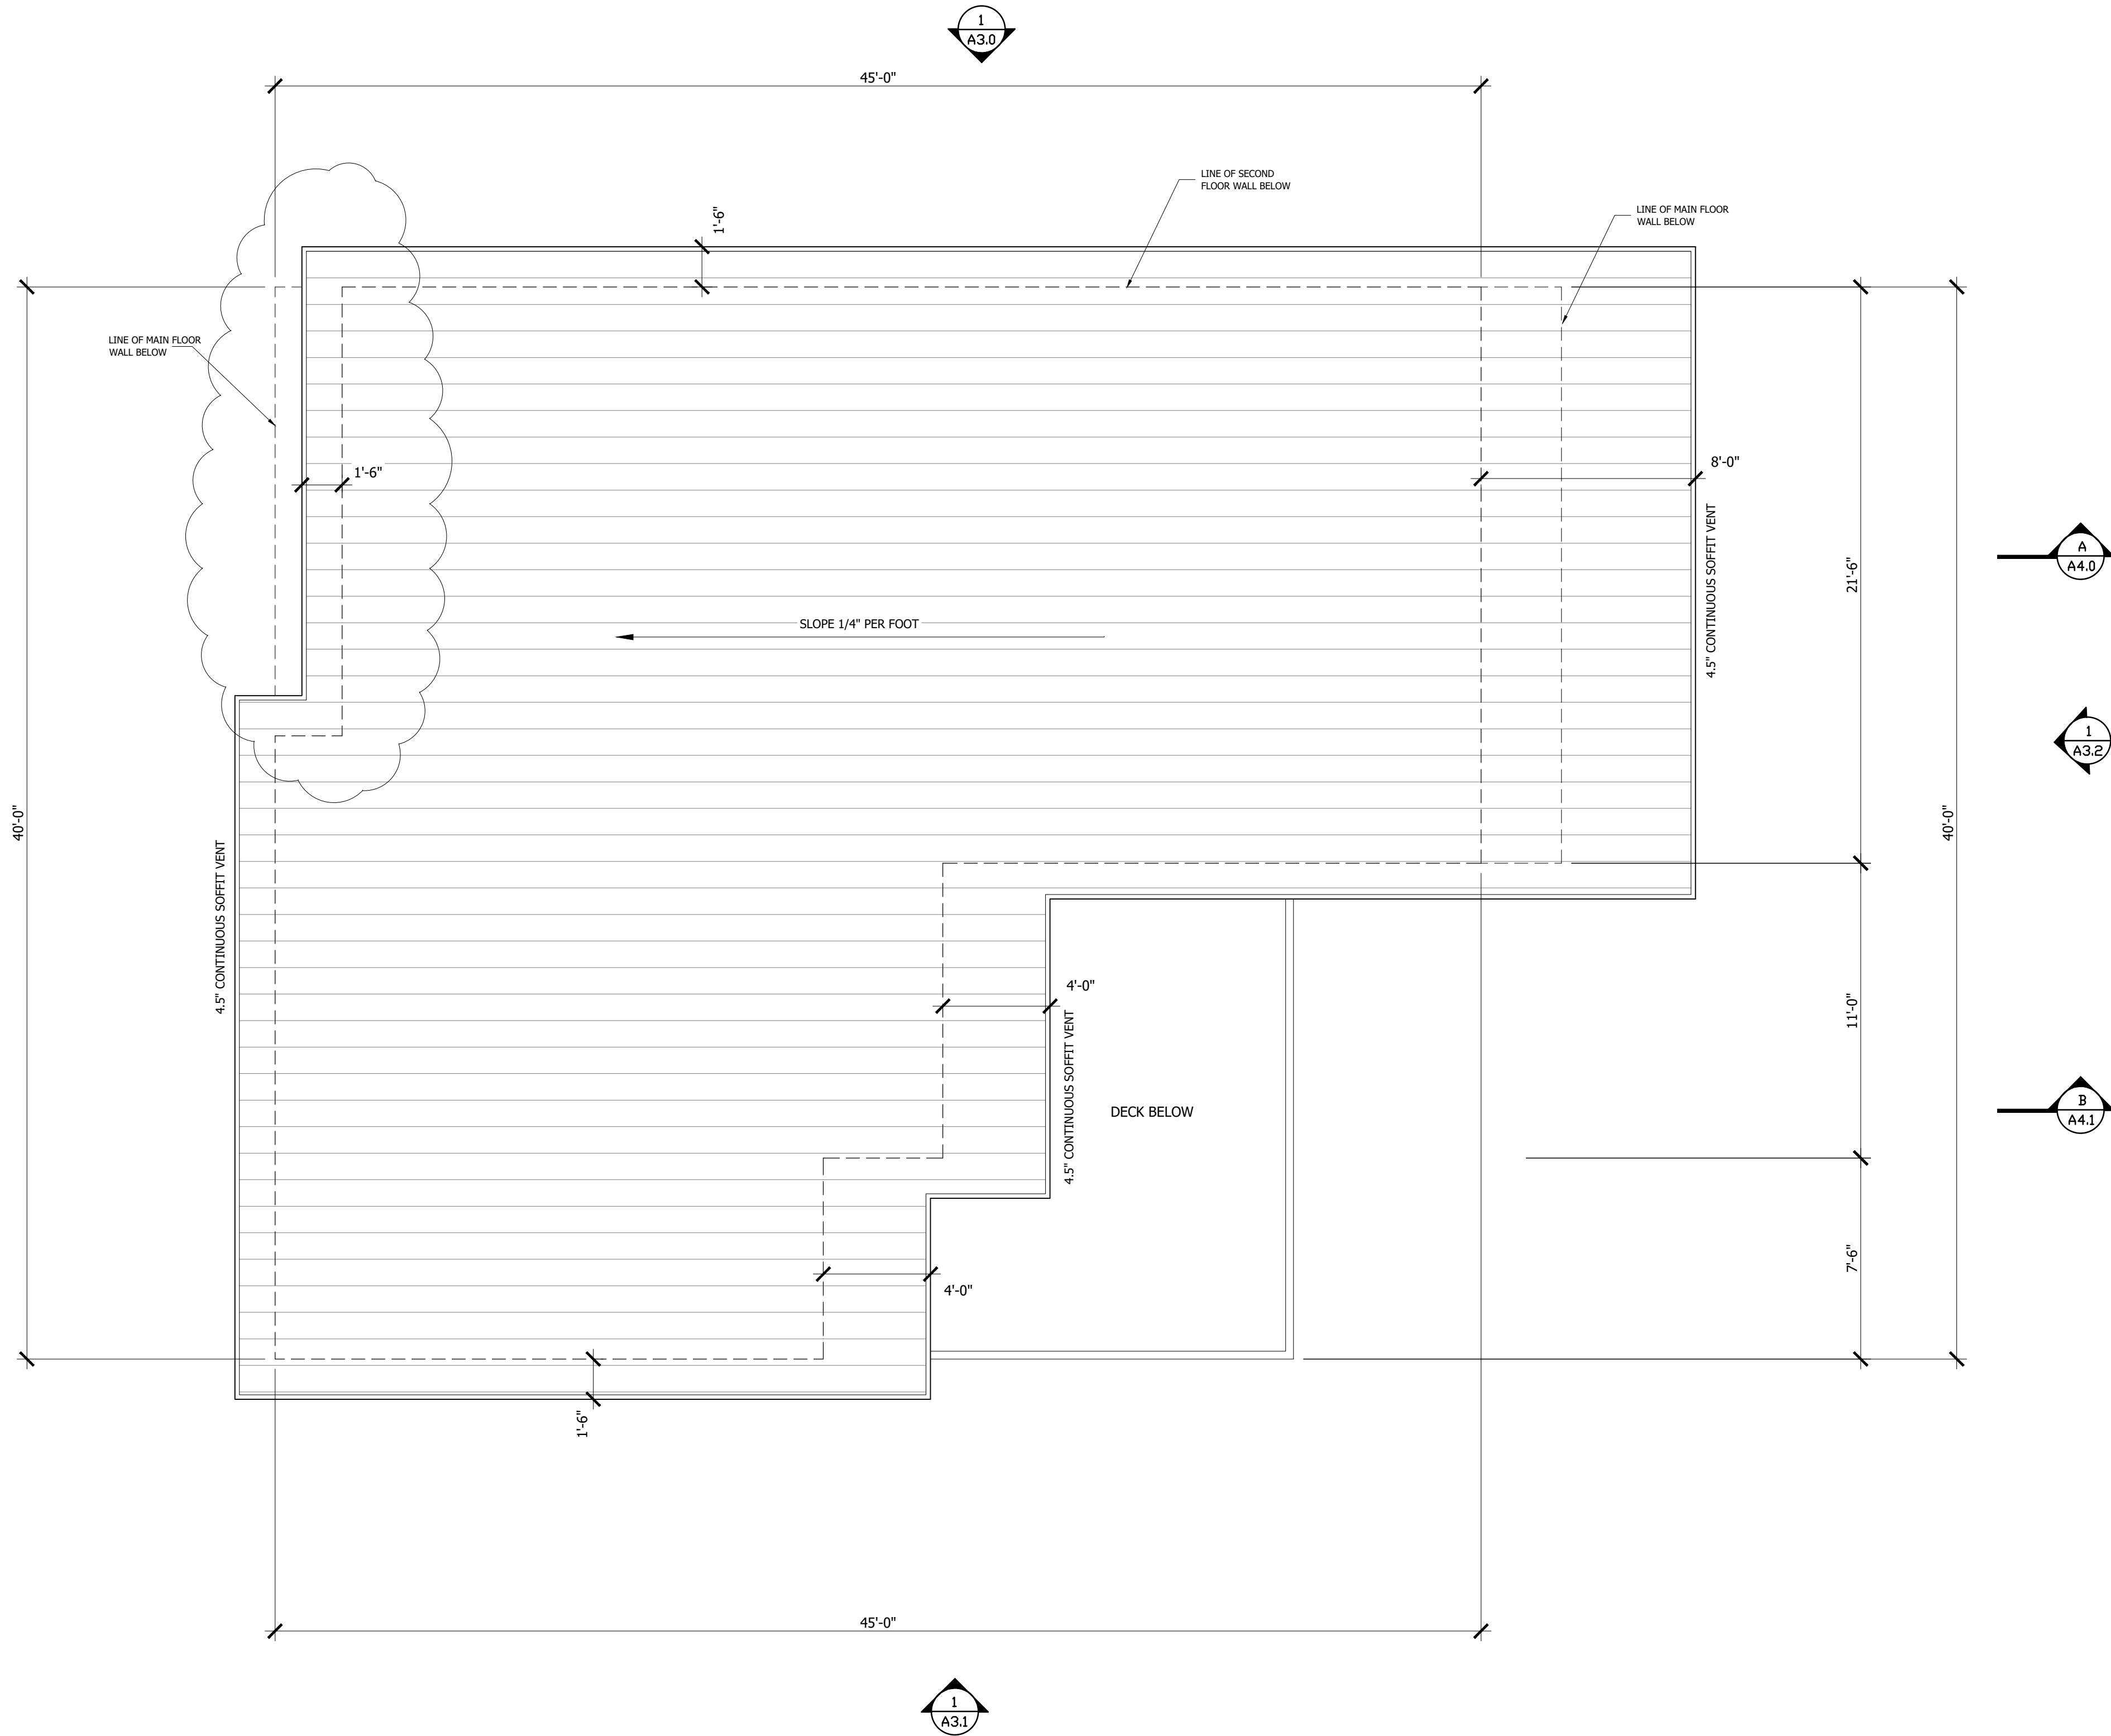

1 **ROOF PLAN**
SCALE: 1/4" = 1'

WINDOW SCHEDULE				
MARK	R.O. SIZE	TYPE	QTY	REMARKS
A	30 X 90	CASEMENT/FIXED	10	TEMPERED LOWER LITE
B	26 X 90	CASEMENT/FIXED	2	TEMPERED LOWER LITE
C	30 X 56	CASEMENT	1	
D	26 X 56	CASEMENT	3	
E	20 X 90	FIXED	1	TEMPERED
F	36 X 90	FIXED	1	TEMPERED
G	26 X 90	FIXED	1	TEMPERED
H	34 X 90	FIXED	1	TEMPERED
I	310 X 90	FIXED	1	TEMPERED
J	30 X 50	CASEMENT	3	
K	26 X 50	CASEMENT	3	
L	20 X 50	FIXED	1	
M	26 X 40	CASEMENT	3	
N	30 X 66	FIXED	1	
O	36 X 76	FIXED	3	
P	110 X 10	FIXED	1	
Q	30 X 76	CASEMENT	2	
R	26 X 76	FIXED	1	TEMPERED
S	34 X 76	FIXED/AWNING	1	TEMPERED AWNING
T	310 X 76	FIXED/AWNING	1	TEMPERED AWNING
U	30 X 46	CASEMENT	2	
V	30 X 40	CASEMENT	2	
W	36 X 40	CASEMENT	1	

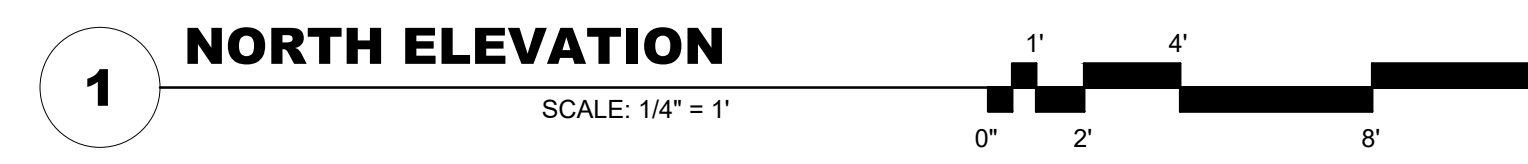

SEAL



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PROJECT

CHESHIRE
 9271 SE 76TH STREET
 MERCER ISLAND, WA 98040

ISSUE INFORMATION

08.17.2021 PERMIT SUBMITTAL

SHEET TITLE

NORTH ELEVATION

SHEET NUMBER

A-3.0

WINDOW SCHEDULE				
MARK	R.O. SIZE	TYPE	QTY	REMARKS
A	30 X 90	CASEMENT/FIXED	10	TEMPERED LOWER LITE
B	26 X 90	CASEMENT/FIXED	2	TEMPERED LOWER LITE
C	30 X 56	CASEMENT	1	
D	26 X 56	CASEMENT	3	
E	20 X 90	FIXED	1	TEMPERED
F	36 X 90	FIXED	1	TEMPERED
G	26 X 90	FIXED	1	TEMPERED
H	34 X 90	FIXED	1	TEMPERED
I	310 X 90	FIXED	1	TEMPERED
J	30 X 50	CASEMENT	3	
K	26 X 50	CASEMENT	3	
L	20 X 50	FIXED	1	
M	26 X 40	CASEMENT	3	
N	30 X 66	FIXED	1	
O	36 X 76	FIXED	3	
P	110 X 10	FIXED	1	
Q	30 X 76	CASEMENT	2	
R	26 X 76	FIXED	1	TEMPERED
S	34 X 76	FIXED/AWNING	1	TEMPERED AWNING
T	310 X 76	FIXED/AWNING	1	TEMPERED AWNING
U	30 X 46	CASEMENT	2	
V	30 X 40	CASEMENT	2	
W	36 X 40	CASEMENT	1	





1 SOUTH ELEVATION
 SCALE: 1/4" = 1'
 0' 2' 4' 8'


WINDOW SCHEDULE				
MARK	R.O. SIZE	TYPE	QTY	REMARKS
A	30 X 90	CASEMENT/FIXED	10	TEMPERED LOWER LITE
B	26 X 90	CASEMENT/FIXED	2	TEMPERED LOWER LITE
C	30 X 56	CASEMENT	1	
D	26 X 56	CASEMENT	3	
E	20 X 90	FIXED	1	TEMPERED
F	36 X 90	FIXED	1	TEMPERED
G	26 X 90	FIXED	1	TEMPERED
H	34 X 90	FIXED	1	TEMPERED
I	310 X 90	FIXED	1	TEMPERED
J	30 X 50	CASEMENT	3	
K	26 X 50	CASEMENT	3	
L	20 X 50	FIXED	1	
M	26 X 40	CASEMENT	3	
N	30 X 66	FIXED	1	
O	36 X 76	FIXED	3	
P	110 X 10	FIXED	1	
Q	30 X 76	CASEMENT	2	
R	26 X 76	FIXED	1	TEMPERED
S	34 X 76	FIXED/AWNING	1	TEMPERED AWNING
T	310 X 76	FIXED/AWNING	1	TEMPERED AWNING
U	30 X 46	CASEMENT	2	
V	30 X 40	CASEMENT	2	
W	36 X 40	CASEMENT	1	



1 EAST ELEVATION
 SCALE: 1/4" = 1'
 0' 2' 4' 8' 16'

WINDOW SCHEDULE				
MARK	R.O. SIZE	TYPE	QTY	REMARKS
A	30 X 90	CASEMENT/FIXED	10	TEMPERED LOWER LITE
B	26 X 90	CASEMENT/FIXED	2	TEMPERED LOWER LITE
C	30 X 56	CASEMENT	1	
D	26 X 56	CASEMENT	3	
E	20 X 90	FIXED	1	TEMPERED
F	36 X 90	FIXED	1	TEMPERED
G	26 X 90	FIXED	1	TEMPERED
H	34 X 90	FIXED	1	TEMPERED
I	310 X 90	FIXED	1	TEMPERED
J	30 X 50	CASEMENT	3	
K	26 X 50	CASEMENT	3	
L	20 X 50	FIXED	1	
M	26 X 40	CASEMENT	3	
N	30 X 66	FIXED	1	
O	36 X 76	FIXED	3	
P	110 X 10	FIXED	1	
Q	30 X 76	CASEMENT	2	
R	26 X 76	FIXED	1	TEMPERED
S	34 X 76	FIXED/AWNING	1	TEMPERED AWNING
T	310 X 76	FIXED/AWNING	1	TEMPERED AWNING
U	30 X 46	CASEMENT	2	
V	30 X 40	CASEMENT	2	
W	36 X 40	CASEMENT	1	

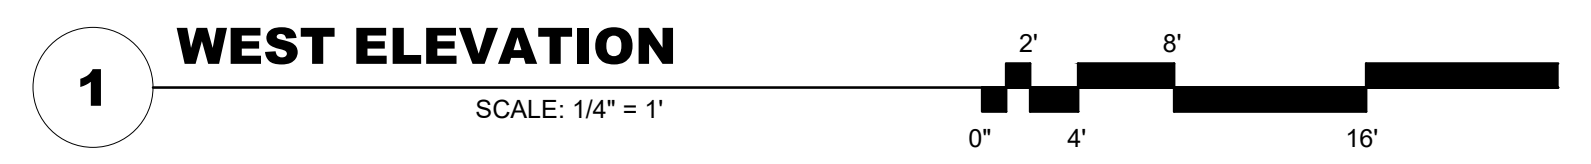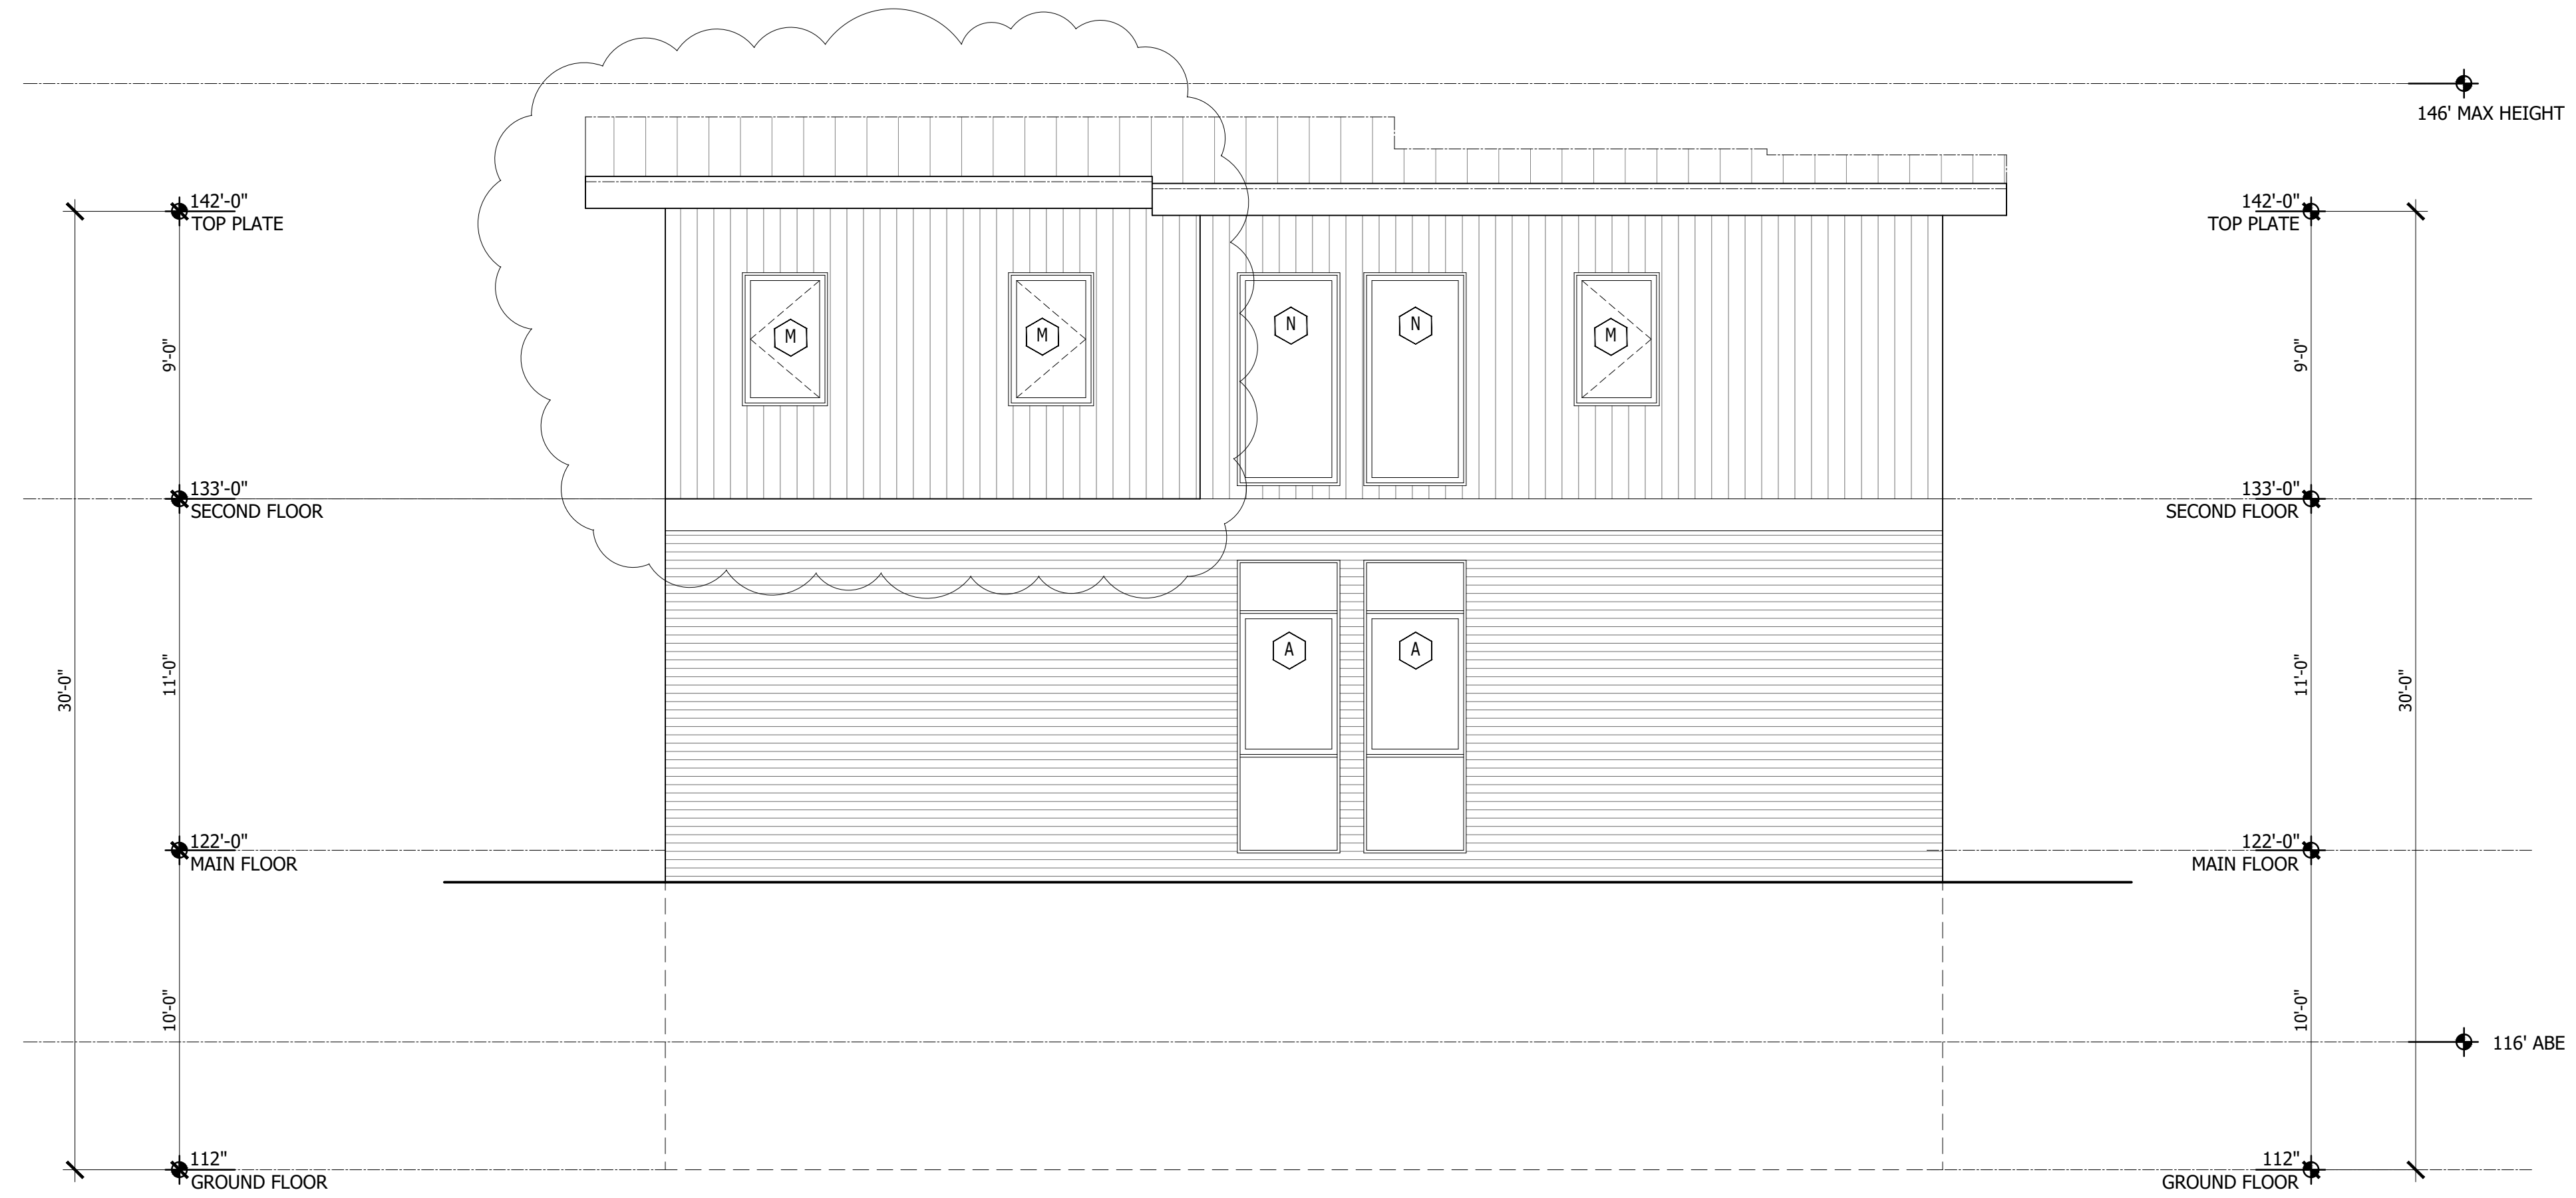

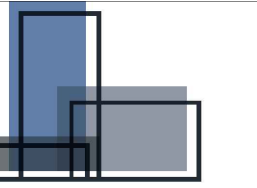

FORMWORKS
DESIGN | BUILD

SEAL



ALLAN BLAIN CLARK
STATE OF WASHINGTON

CONSULTANT

PROJECT

CHESHIRE

92XX SE 76TH STREET
MERCER ISLAND, WA 98040

ISSUE INFORMATION

08.17.2021 PERMIT SUBMITTAL

SHEET TITLE

SECTION A-A

SHEET NUMBER

A-4.0

F1 TYPICAL SLAB ON GRADE FLOOR
FINISH FLOOR PER PLANS
UNDERLAYMENT
CONCRETE SLAB PER STRUCTURAL
R-10 RIGID INSULATION ENTIRE SLAB
6 MIL. VAPOR BARRIER
6" FREE DRAINING MATERIAL

F2 FLOOR OVER UNHEATED GARAGE
FINISH FLOOR PER PLANS
UNDERLAYMENT
3/4" PLYWOOD SUBFLOOR.
FLOOR JOISTS PER STRUCTURAL
2 LAYERS 1/2" TYPE "X" G.W.B.

F3 FLOOR OVER HEATED SPACE
FINISH FLOOR PER PLANS
UNDERLAYMENT
3/4" PLYWOOD SUBFLOOR.
FLOOR JOISTS PER STRUCTURAL
5/8" G.W.B.



W1 BELOW GRADE WALL
DRAINAGE MAT
SPRAY ON WATERPROOFING
CONCRETE WALL PER STRUCTURAL
2 X 4 STUDS @ 16" O.C. SET OFF FROM CONCRETE
R-21 BATT INSULATION G.W.B.
5/8" G.W.B


W2 TYPICAL EXTERIOR WALL
WALL FINISH PER ELEVATIONS
2 LAYERS 60 MIN. BUILDING PAPER
PLYWOOD SHEATHING PER STRUCTURAL
2 X 6 STUDS @ 16" O.C.
R-21 KRAFT FACED BATT INSULATION
5/8" G.W.B.

W3 TYPICAL INTERIOR WALL
5/8" G.W.B
2 X 4 STUDS @ 16" O.C.
5/8" G.W.B

R1 TYPICAL SLOPED ROOF
STANDING SEAM METAL ROOFING
30# BUILDING FELT
SHEATHING PER STRUCTURAL
ROOF JOISTS PER STRUCTURAL
R-14 CLOSED CELL SPRAY FOAM INSULATION AND
R-25 BATT INSULATION (MIN R-49 COMBINED)
5/8" G.W.B

R2 FLAT ROOF DECK OVER HEATED SPACE
FINISH DECKING PER PLANS
TAPERED 2X SLEEPERS
MEMBRANE ROOFING
SHEATHING PER STRUCTURAL
R-14 CLOSED CELL SPRAY FOAM INSULATION AND
R-25 BATT INSULATION (MIN R-49 COMBINED)
5/8" G.W.B.

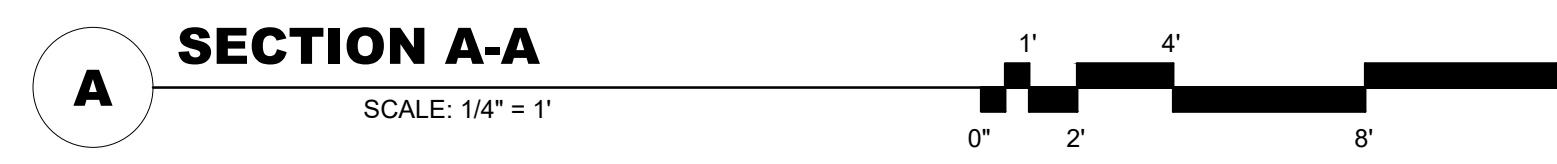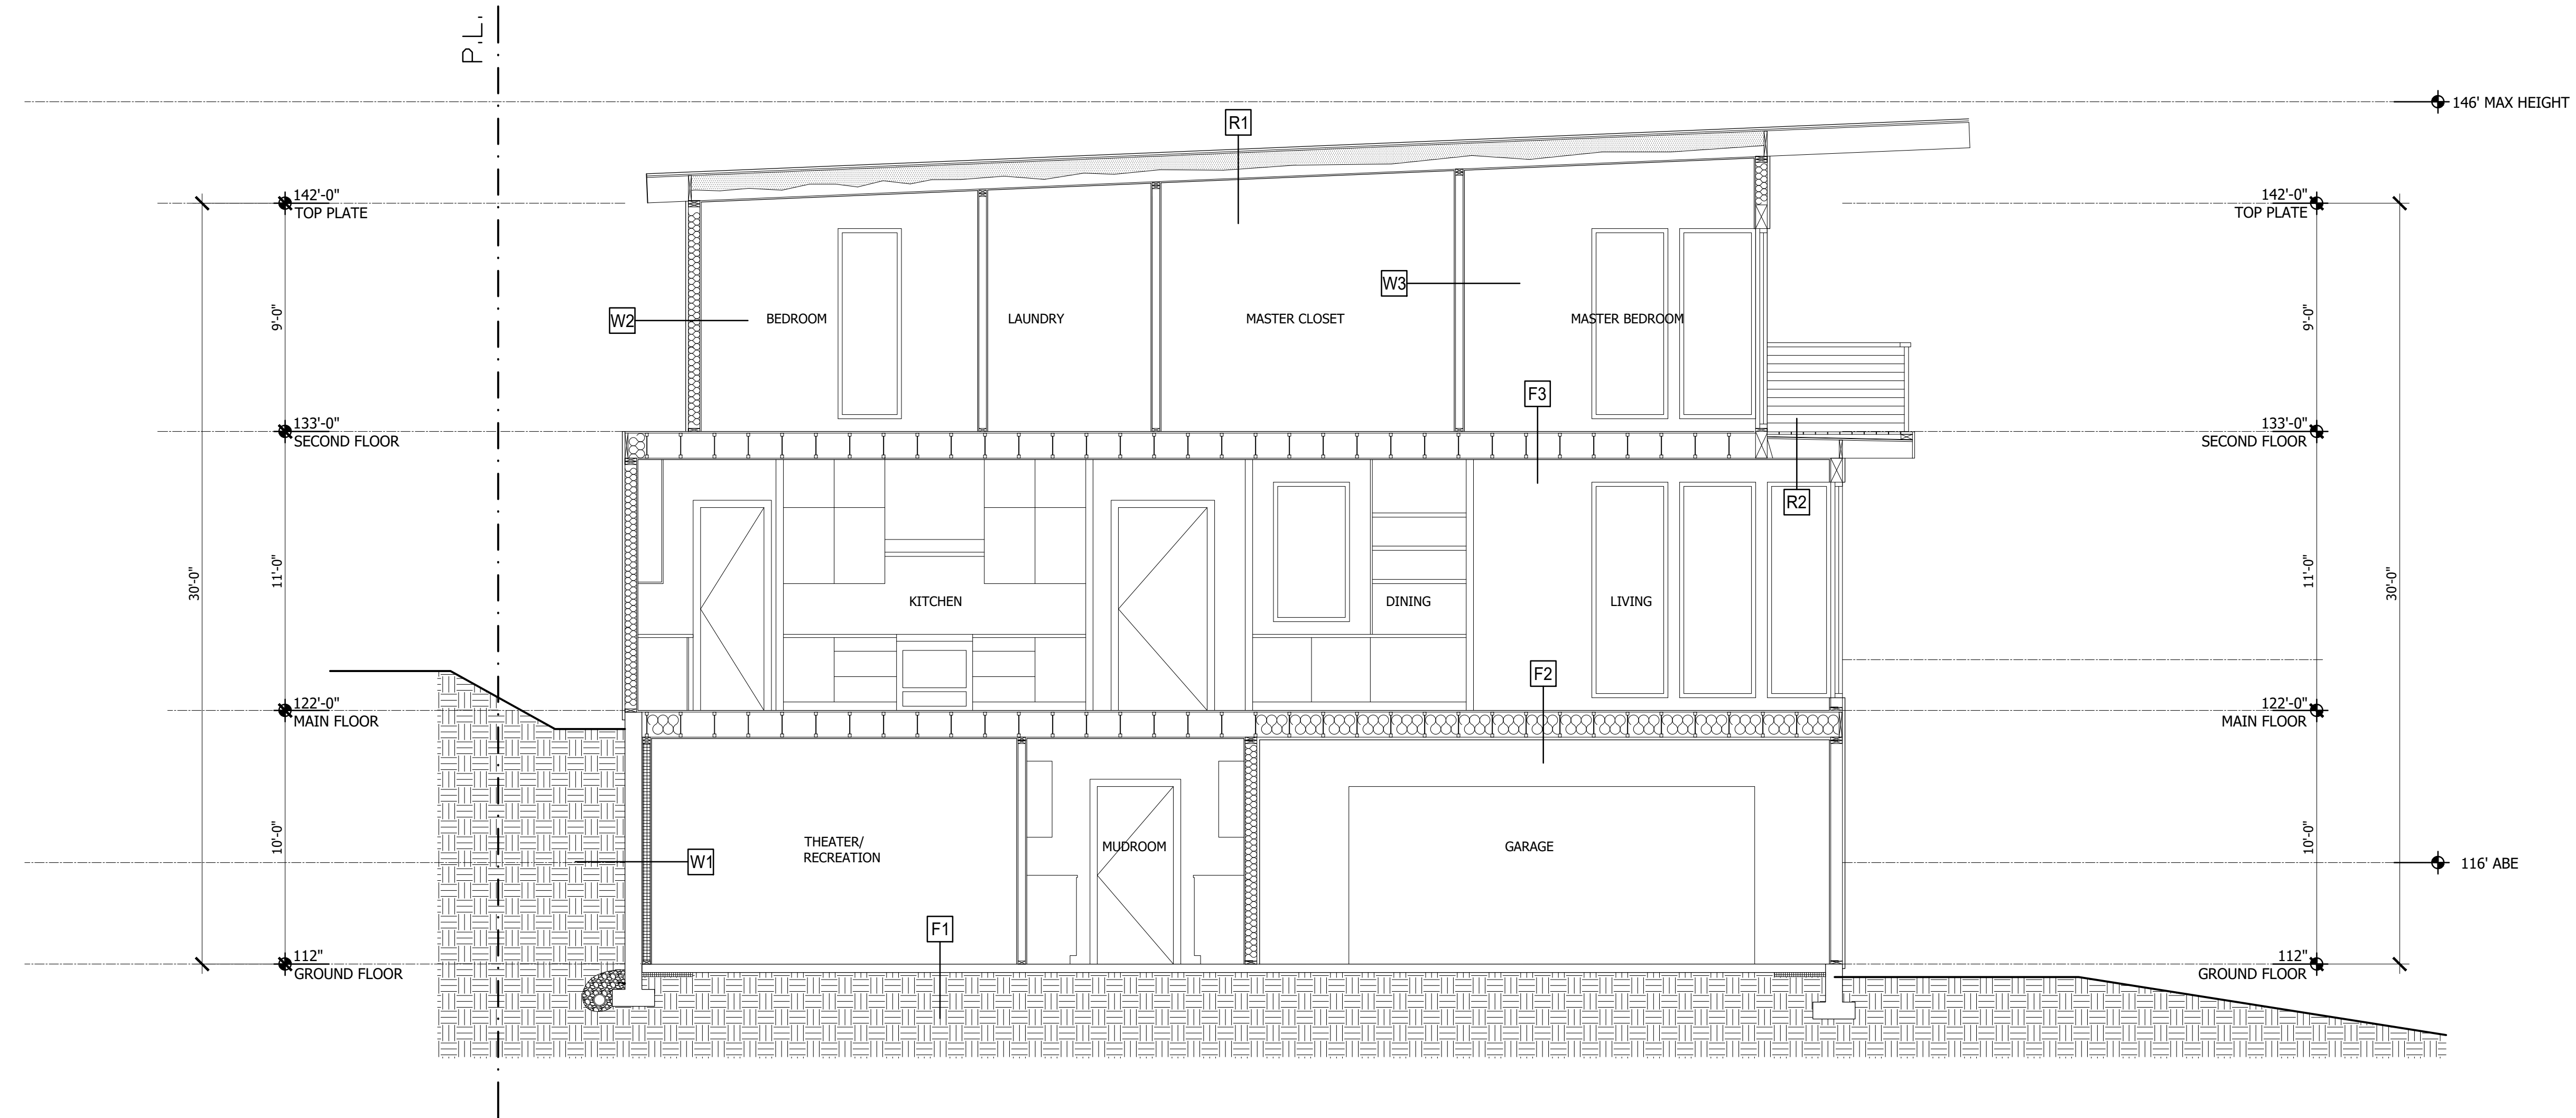

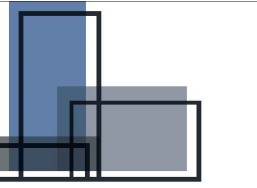

FORMWORKS
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CONSULTANT

PROJECT

CHESHIRE
9271 SE 76TH STREET
MERCER ISLAND, WA 98040

ISSUE INFORMATION

08.17.2021 PERMIT SUBMITTAL

SHEET TITLE

SECTION B-B

SHEET NUMBER

A-4.1

F1 TYPICAL SLAB ON GRADE FLOOR
FINISH FLOOR PER PLANS
UNDERLAYMENT
CONCRETE SLAB PER STRUCTURAL
R-10 RIGID INSULATION ENTIRE SLAB
6 MIL. VAPOR BARRIER
6" FREE DRAINING MATERIAL

F2 FLOOR OVER UNHEATED GARAGE
FINISH FLOOR PER PLANS
UNDERLAYMENT
3/4" PLYWOOD SUBFLOOR.
FLOOR JOISTS PER STRUCTURAL
2 LAYERS 1/2" TYPE "X" G.W.B.

F3 FLOOR OVER HEATED SPACE
FINISH FLOOR PER PLANS
UNDERLAYMENT
3/4" PLYWOOD SUBFLOOR.
FLOOR JOISTS PER STRUCTURAL
5/8" G.W.B.



W1 BELOW GRADE WALL
DRAINAGE MAT
SPRAY ON WATERPROOFING
CONCRETE WALL PER STRUCTURAL
2 X 4 STUDS @ 16" O.C. SET OFF FROM CONCRETE
R-21 BATT INSULATION G.W.B.
5/8" G.W.B.

W2 TYPICAL EXTERIOR WALL
WALL FINISH PER ELEVATIONS
2 LAYERS 60 MIN. BUILDING PAPER
PLYWOOD SHEATHING PER STRUCTURAL
2 X 6 STUDS @ 16" O.C.
R-21 KRAFT FACED BATT INSULATION
5/8" G.W.B.

W3 TYPICAL INTERIOR WALL
5/8" G.W.B.
2 X 4 STUDS @ 16" O.C.
5/8" G.W.B.

R1 TYPICAL SLOPED ROOF
STANDING SEAM METAL ROOFING
30# BUILDING FELT
SHEATHING PER STRUCTURAL
ROOF JOISTS PER STRUCTURAL
R-14 CLOSED CELL SPRAY FOAM INSULATION AND
R-25 BATT INSULATION (MIN R-49 COMBINED)
5/8" G.W.B.

R2 FLAT ROOF DECK OVER HEATED SPACE
FINISH DECKING PER PLANS
TAPERED 2X SLEEPERS
MEMBRANE ROOFING
SHEATHING PER STRUCTURAL
R-14 CLOSED CELL SPRAY FOAM INSULATION AND
R-25 BATT INSULATION (MIN R-49 COMBINED)
5/8" G.W.B.

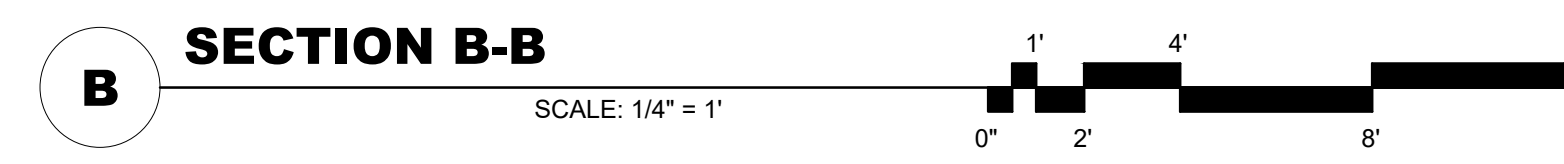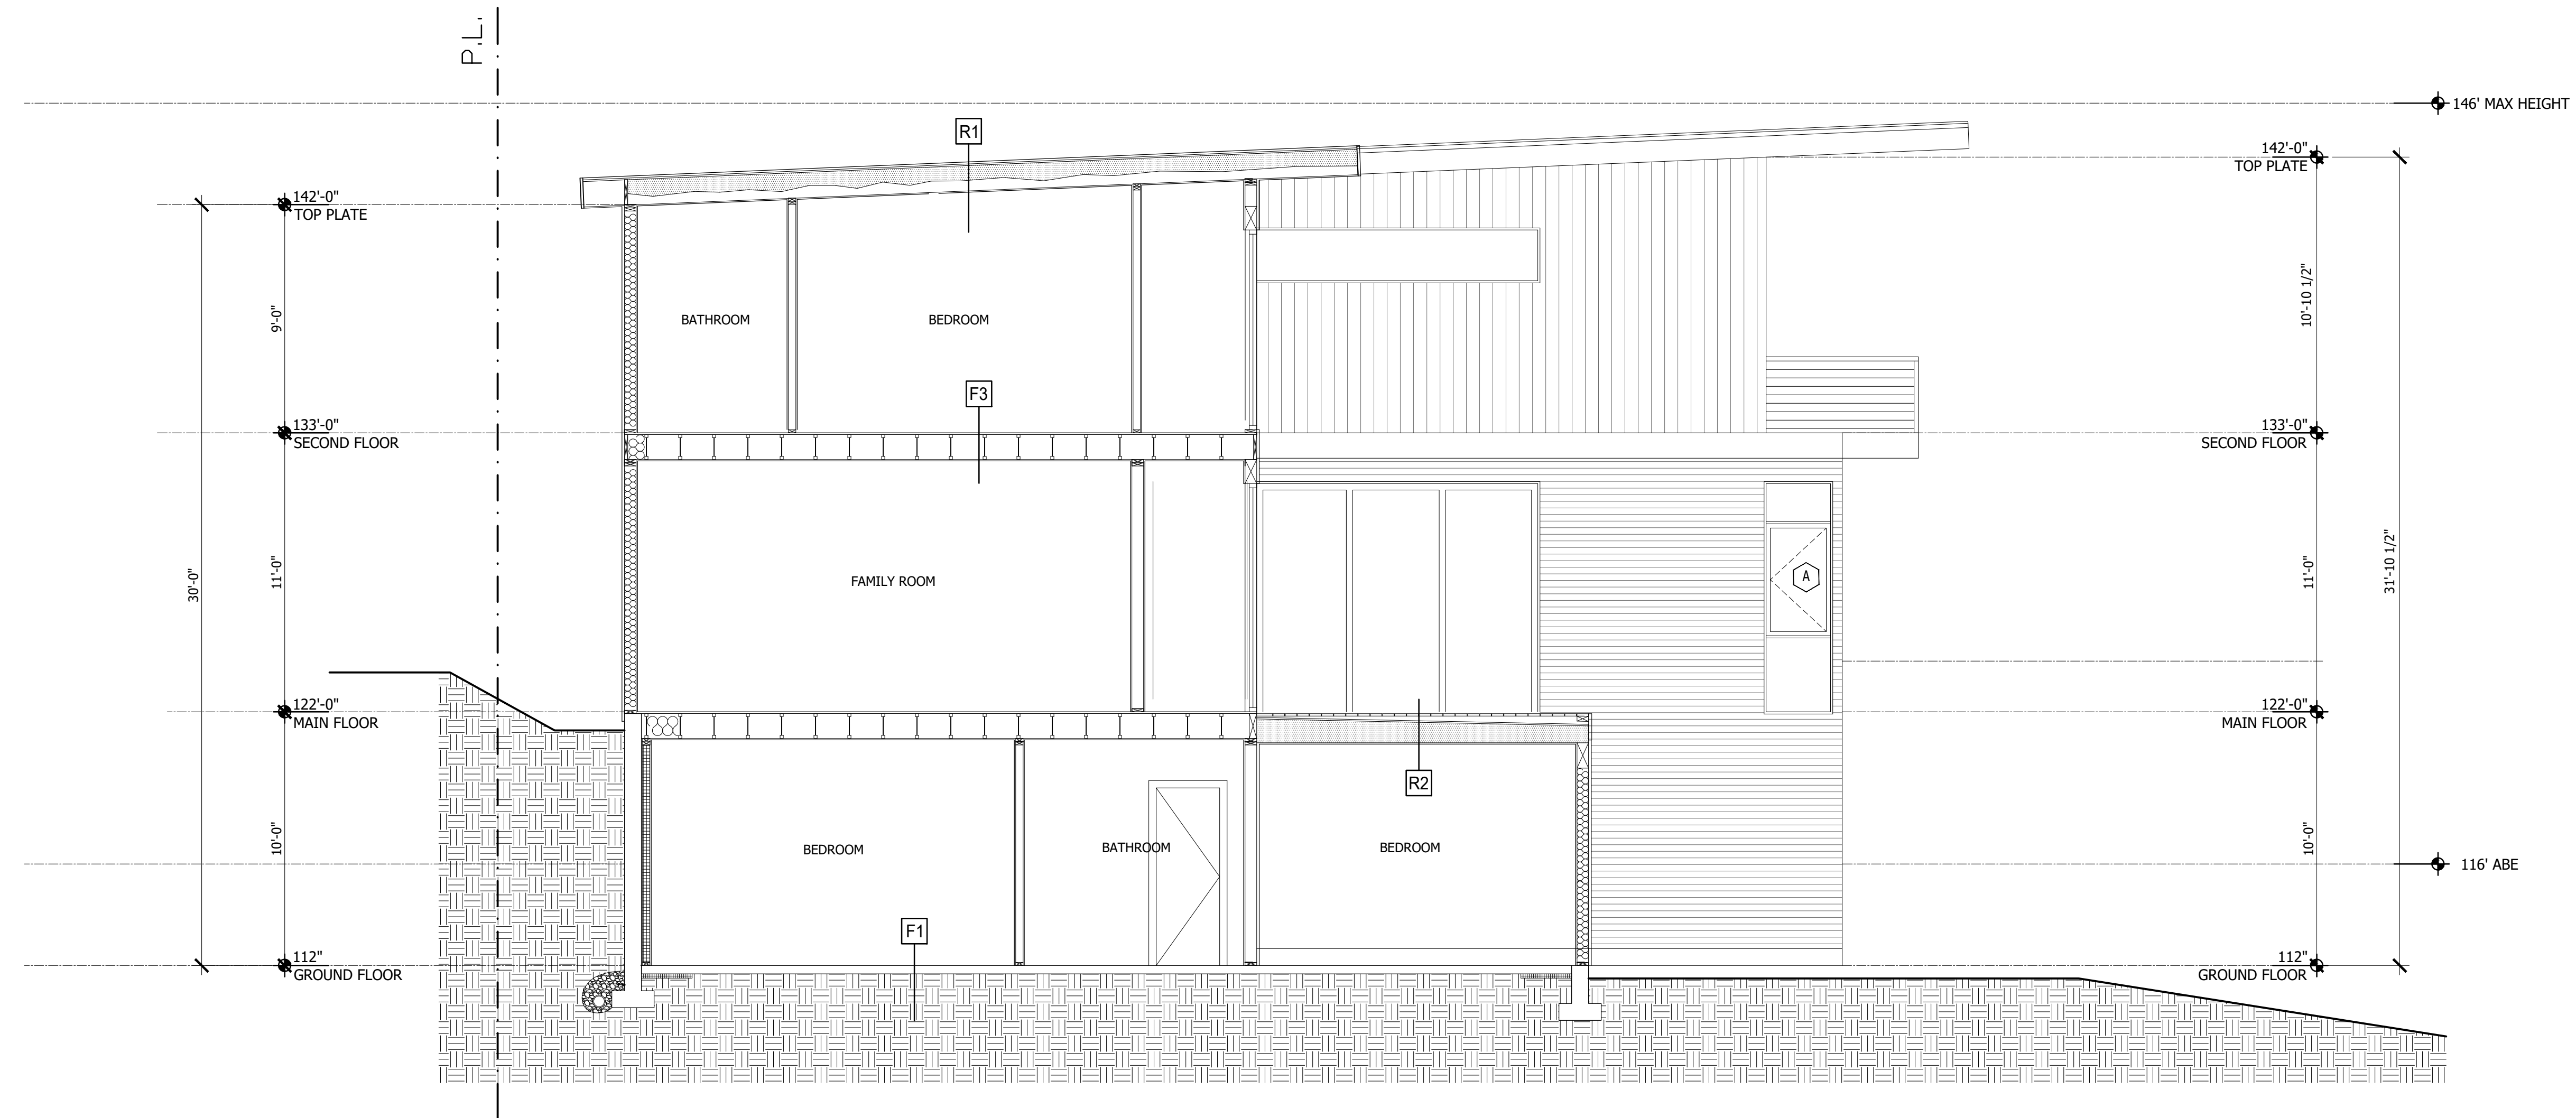


FOUNDATION PLAN NOTES:

1. VERIFY LOCATIONS OF NEW COLUMNS, WALLS, OPENINGS, ETC. WITH ARCHITECTURAL DRAWINGS BEFORE PLACING FOUNDATIONS. PROVIDE BLOCKOUTS FOR PLUMBING, HVAC, AND SPECIAL EQUIPMENT AS SHOWN ON ARCHITECTURAL AND MEP PLANS.
2. TOP OF SLAB ELEVATION ASSUMED AT 112'-0" EXCEPT AS NOTED. REFERENCE CIVIL AND ARCHITECTURAL PLANS FOR ACTUAL TOP OF SLAB ELEVATION. REFERENCE ARCHITECTURAL DRAWINGS FOR DAMPPROOFING AND WATERPROOFING REQUIREMENTS FOR SLAB AND BASEMENT WALLS.
3. DESIGN SOIL BEARING PRESSURE OF 2000 PSF BASED ON IBC 2018 TABLE 1806.2.
4. ALL EXTERIOR FOOTINGS SHALL BEAR AT OR BELOW THE MINIMUM FROST DEPTH OF 12" BELOW FINISHED GRADE. ALL INTERIOR FOOTINGS SHALL BEAR A MINIMUM OF 12 INCHES BELOW TOP OF SLAB.
5. ALL FOOTINGS AND SLABS SHALL BEAR ON COMPETANT NATIVE SOIL OR STRUCTURAL FILL. ALL FILL SHALL BE COMPACTED IN LIFTS OF 8 INCHES MAXIMUM AND COMPACTED TO MINIMUM 95% OF MODIFIED PROCTOR.
6. PROVIDE PRESSURE TREATED WOOD AT ALL LOCATIONS WHERE IN CONTACT WITH CONCRETE, WITHIN 8" OF EXPOSED GRADE, OR NOT OTHERWISE WEATHERPROOFED.
7. REFERENCE HOLD-DOWN SCHEDULE AND SHEAR WALL SCHEDULE FOR HOLD-DOWN ANCHOR AND SILL PLATE ANCHORAGE REQUIREMENTS.
8. REFERENCE THE STRUCTURAL GENERAL NOTES FOR DESIGN CRITERIA, LEGEND, AND ABBREVIATIONS.

STUD AND SHEAR WALL PLAN NOTES:

1. ALL EXTERIOR WALLS AND INTERIOR BEARING WALLS SHALL BE PER THE PLANS OR STUD WALL SCHEDULE, UNLESS NOTED OTHERWISE. STUDS SHALL ALIGN NOMINALLY FLOOR TO FLOOR WITH STUDS, JOISTS, AND TRUSSES. ATTACH SILL PLATES TO CONCRETE, RIM BOARD, OR TOP PLATE PER SCHEDULE, UNO IN SHEAR WALL SCHEDULE.
2. REFERENCE THE STRUCTURAL GENERAL NOTES FOR DESIGN CRITERIA, LUMBER GRADES, LEGEND, AND ABBREVIATIONS.
3. PROVIDE MINIMUM BLOCKING AT 5'-0" OC MAX FOR ALL BEARING AND EXTERIOR WALLS. REFER TO SHEAR WALL SCHEDULE FOR ADDITIONAL BLOCKING REQUIREMENTS.
4. PROVIDE MINIMUM SILL ANCHORAGE OF 5/8" X 7" EMBED BOLTS AT 48" OC UNLESS NOTED OTHERWISE ON SHEARWALL SCHEDULE. BOLTS SHALL BE GALVANIZED AT PRESSURE TREATED SILL PLATES.
5. FOR SHEAR WALL STRAPS AND ATTACHMENT REQUIREMENTS, REFERENCE THE SHEAR WALL SCHEDULE.
6. INDICATES HOLD-DOWN TYPE, REFERENCE HOLD-DOWN SCHEDULE.

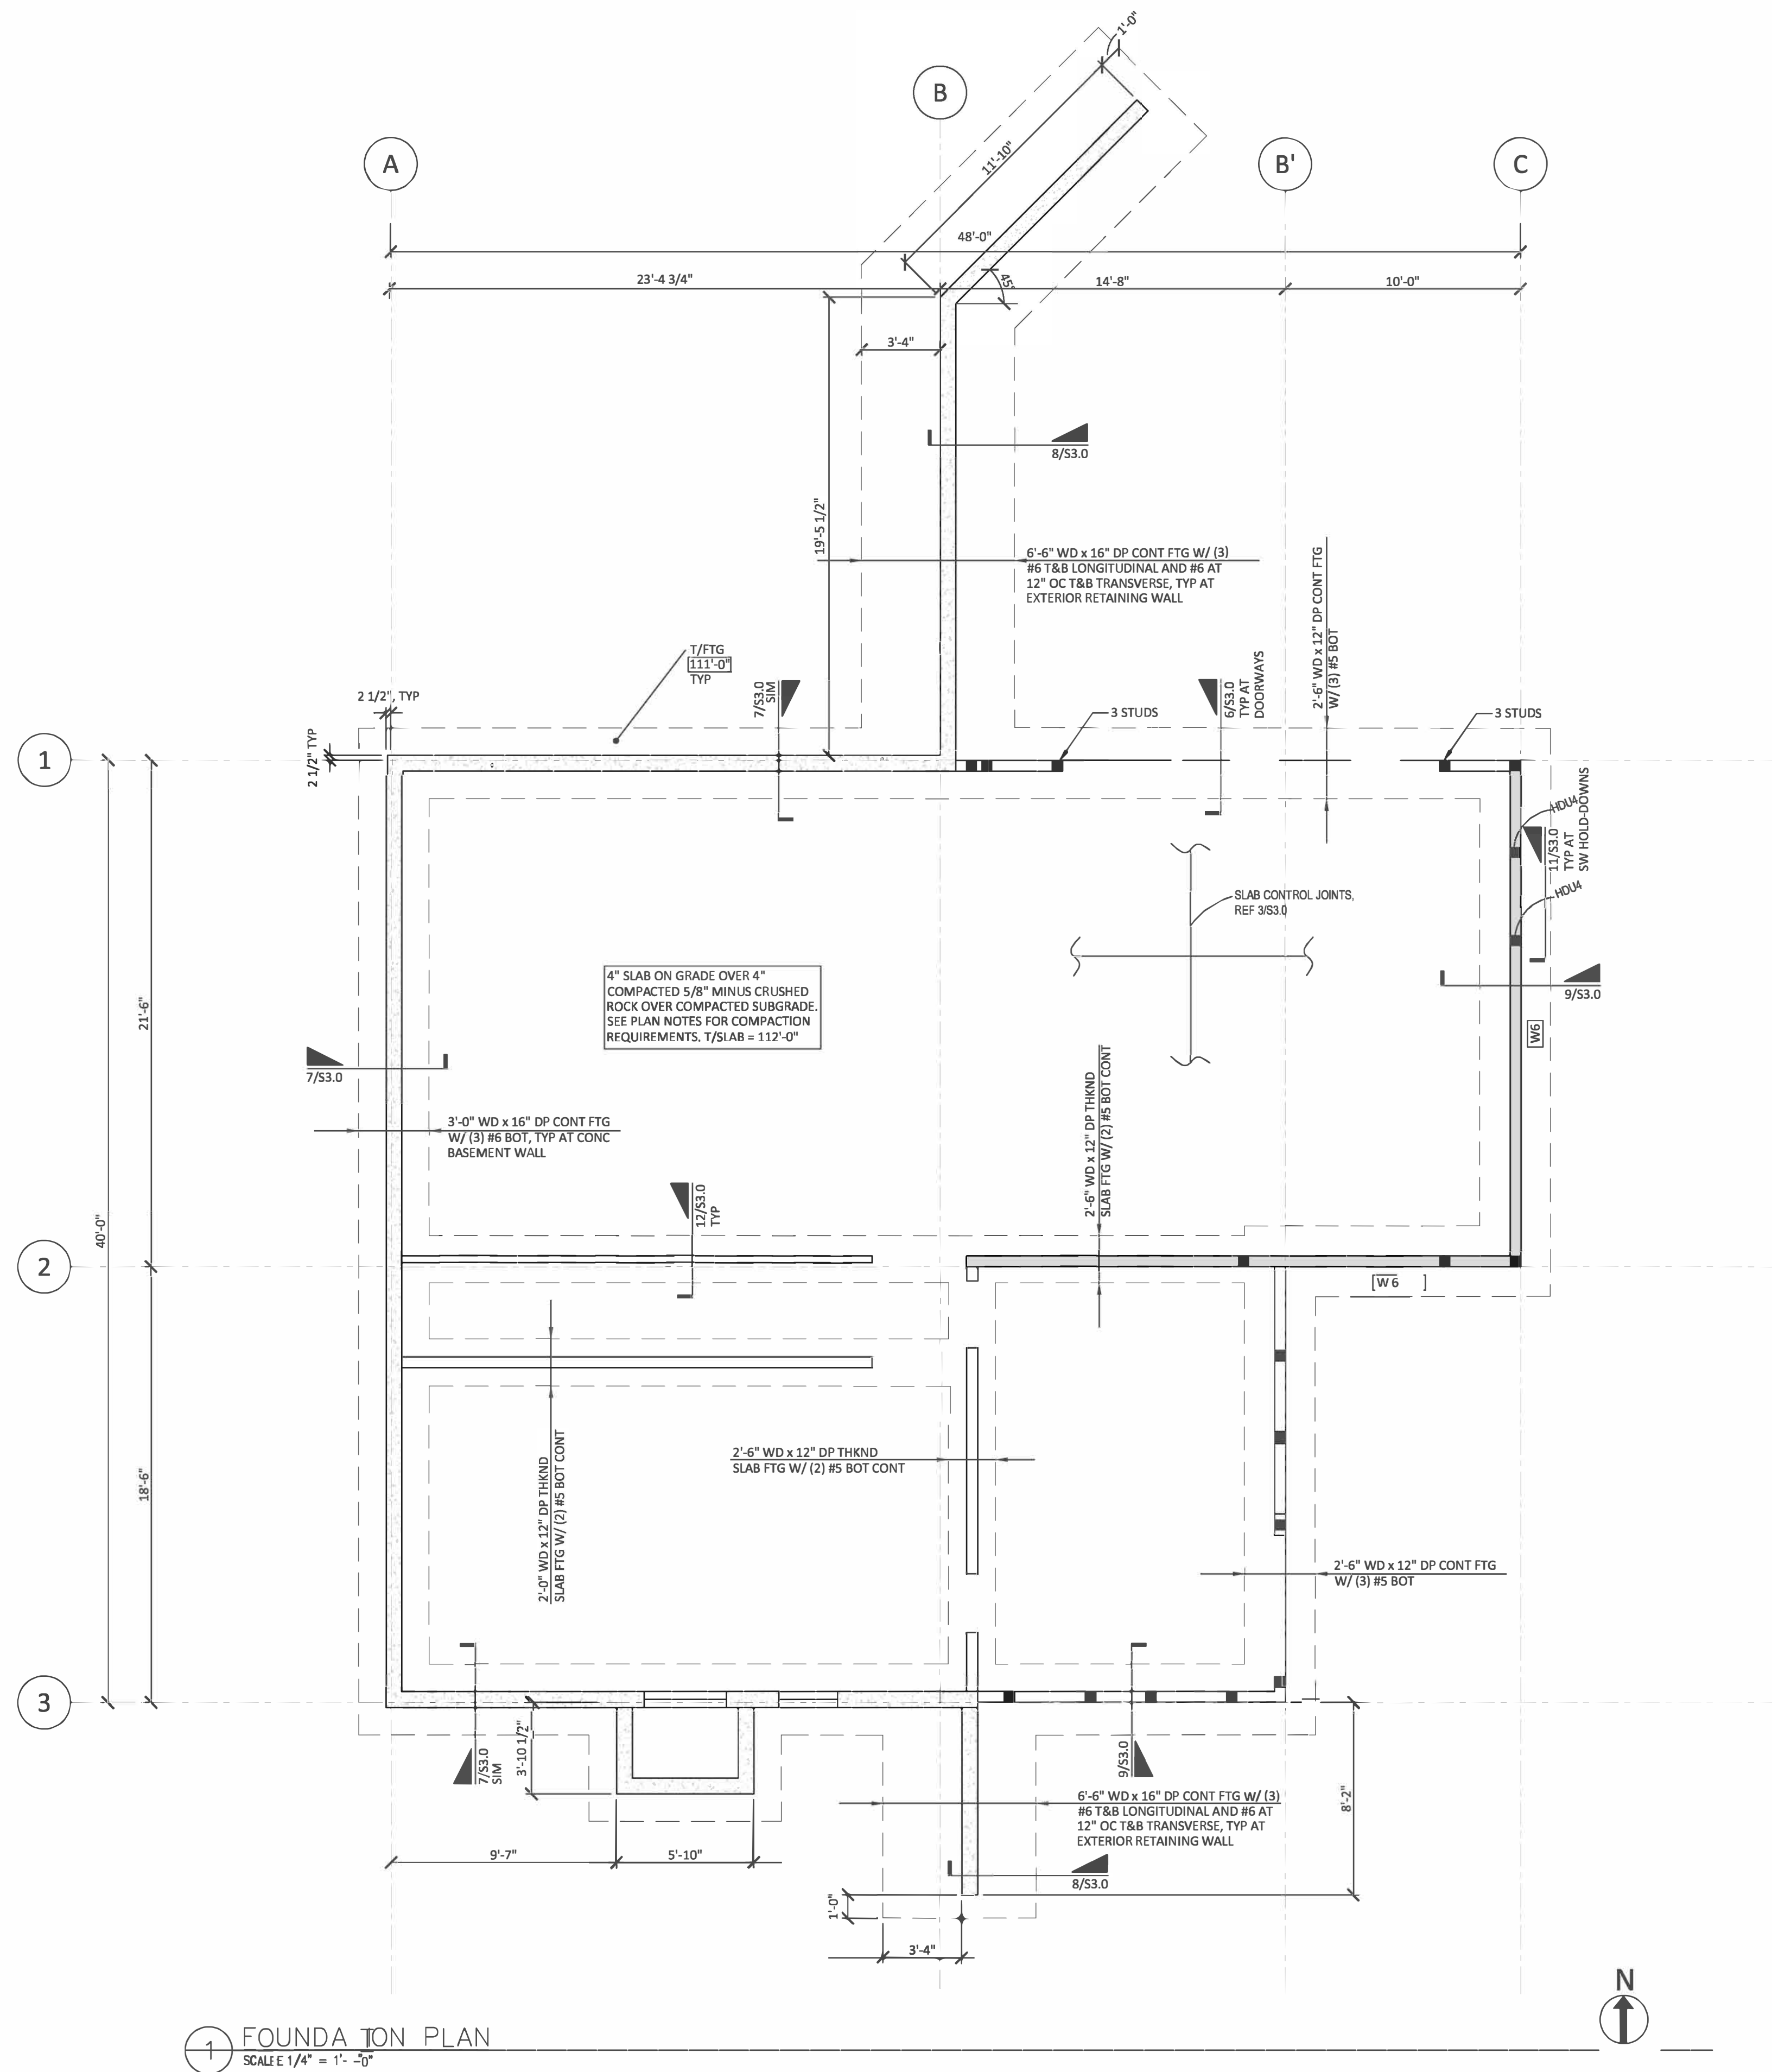

FOUNDATION PLAN
SCALE 1/4" = 1'-0"



MERRELL DESIGN SERVICES PLLC
Nine Mile Falls, Washington 99026
509-998-7410
TJ@MDSstructural.com

PROJECT:
CHESHIRE

COMPANY:
N/A

JOB SITE ADDRESS:
92XX SE 76TH STREET
MERCER ISLAND, WA 98040

ARCHITECT:
Formworks Design Build
7434 SE 71st St
Mercer Island, WA
98040

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DRAWING ISSUE RECORD:

NO.	STATUS	DATE
	FOR PERMIT	08/12/2021

REVISION RECORD:

REV.	BY:	DESCRIPTION	DATE
1			
2			
3			
4			
5			

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JOB#
2020

SHEET TITLE:
FOUNDATION PLAN

SHEET#: **S2.0** SCALE:
AS SHOWN

DRAWN: DATE: CHECKED: DATE:
MAF 08/12/2021 TJM 08/12/2021



MERRELL DESIGN SERVICES PLLC
 Nine Mile Falls, Washington 99026
 509-998-7410
 TJ@MDSstructural.com

PROJECT:
CHESHIRE

COMPANY:
 N/A

JOB SITE ADDRESS:
 92XX SE 76TH STREET
 MERCER ISLAND, WA 98040

ARCHITECT:
 Formworks Design Build
 7434 SE 71st St
 Mercer Island, WA
 98040

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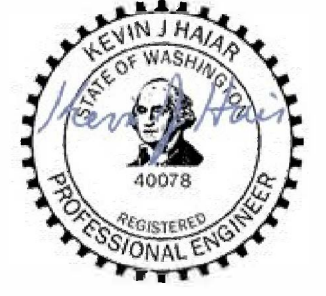
DRAWING ISSUE RECORD:

NO.	STATUS	DATE
	FOR PERMIT	08/12/2021

REVISION RECORD:

REV.	BY:	DESCRIPTION	DATE
1			
2			
3			
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JOB#
 2020

SHEET TITLE:
FIRST FLOOR FRAMING PLAN

SHEET#: **S2.1** SCALE: AS SHOWN

DRAWN:	DATE:	CHECKED:	DATE:
MAF	08/12/2021	TJM	08/12/2021

FLOOR FRAMING PLAN NOTES:

- VERIFY LOCATIONS OF NEW COLUMNS, WALLS, OPENINGS, ETC. WITH ARCHITECTURAL DRAWINGS. VERIFY ALL WALL, FLOOR, AND ROOF ELEVATIONS WITH ARCHITECTS DRAWINGS.
- COORDINATE FRAMING WITH ALL MECHANICAL, HVAC, SPRINKLER, PLUMBING, AND ELECTRICAL DRAWINGS.
- ALL WOOD EXPOSED TO WEATHER, OR IN CONTACT WITH CONCRETE, OR WITHIN 8" OF GRADE SHALL BE PRESSURE TREATED.
- PROVIDE SOLID BLOCKING BETWEEN FLOOR JOISTS/TRUSSES OVER ALL BEARING WALLS AND SHEAR WALLS.
- ALL HORIZONTAL STRAP TIES INDICATED ON PLANS SHALL BE ALIGNED WITH TOP PLATE OR BEAM AND BE CENTERED OVER THE JOINT BETWEEN ADJOINING ELEMENTS. REFERENCE THE STRAP MANUFACTURER FOR FASTENER SIZE AND SPACING.
- ALL JOIST HANGERS SHALL BE SIMPSON TOP FLANGE BEARING JB TYPE, UNO. GLULAM HANGERS SHALL BE HGLTV UNLESS NOTED OTHERWISE ON PLAN. ENGINEERED "I" JOIST HANGERS SHALL BE DESIGNED AND SUPPLIED BY THE JOIST SUPPLIER.
- ALL HEADERS SHALL BE MINIMUM (2) 2X10 FOR SPANS UP TO 3 FEET AND MINIMUM 5 1/8 X 12 GLULAM FOR SPANS UP TO 6 FEET, UNLESS INDICATED OTHERWISE. ALL HEADERS AND BEAMS SHALL BE SUPPORTED BY A MINIMUM OF (2) TRIMMER AND (1) KING STUD. REFERENCE THE PLANS FOR LARGER POSTS OR ADDITIONAL TRIMMERS WHERE REQUIRED. TRIMMER STUDS OR POSTS SHALL BE CONTINUOUS TO THE FOUNDATION UNLESS SUPPORTED BY TRANSFER BEAM.
- REFERENCE SHEAR WALL SCHEDULE FOR SHEAR WALL TYPES AND CONSTRUCTION REQUIREMENTS.
- REFERENCE THE STRUCTURAL GENERAL NOTES FOR DESIGN CRITERIA, LEGEND, AND ABBREVIATIONS.
- PROVIDE JOIST/TRUSS BRIDGING PER MANUFACTURERS REQUIREMENTS FOR ALL ENGINEERED JOISTS AND TRUSSES.
- PROVIDE DOUBLE JOISTS OR DOUBLE BLOCKING AROUND ENTIRE PERIMETER OF OPENINGS GREATER THAN ONE JOIST BAY. PROVIDE DOUBLE JOIST HANGER AT ENDS OF BLOCKING.
- FLOOR SHEATHING SHALL BE AS FOLLOWS:


FLOOR SHEATHING			
SIZE	EDGE NAILING	FIELD NAILING	SPAN RATING
23/32"	0.131 X 2.5" @ 6" OC	0.131 X 2.5" @ 12" OC	24 OC

NOTES:


- ALL SHEATHING SHALL BE APA-RATED.
- LAY SHEATHING WITH FACE GRAIN PERPENDICULAR TO SUPPORTS.
- STAGGER ALL SHEATHING PANEL END JOINTS
- PROVIDE 1/8" GAP BETWEEN PANEL ENDS AND EDGES
- FLOOR SHEATHING SHALL BE STURD-I FLOOR GRADE.

- STRUCTURAL WALL STUD SIZES ARE AS FOLLOWS. REFERENCE THE GENERAL NOTES FOR LUMBER SPECIES:

STRUCTURAL WALL STUD SIZES (minimum)			
Wall	Stud Size	Spacing	Grade
Interior Bearing	2x4	16" OC	no 2
Exterior	2x6	16" OC	no 2

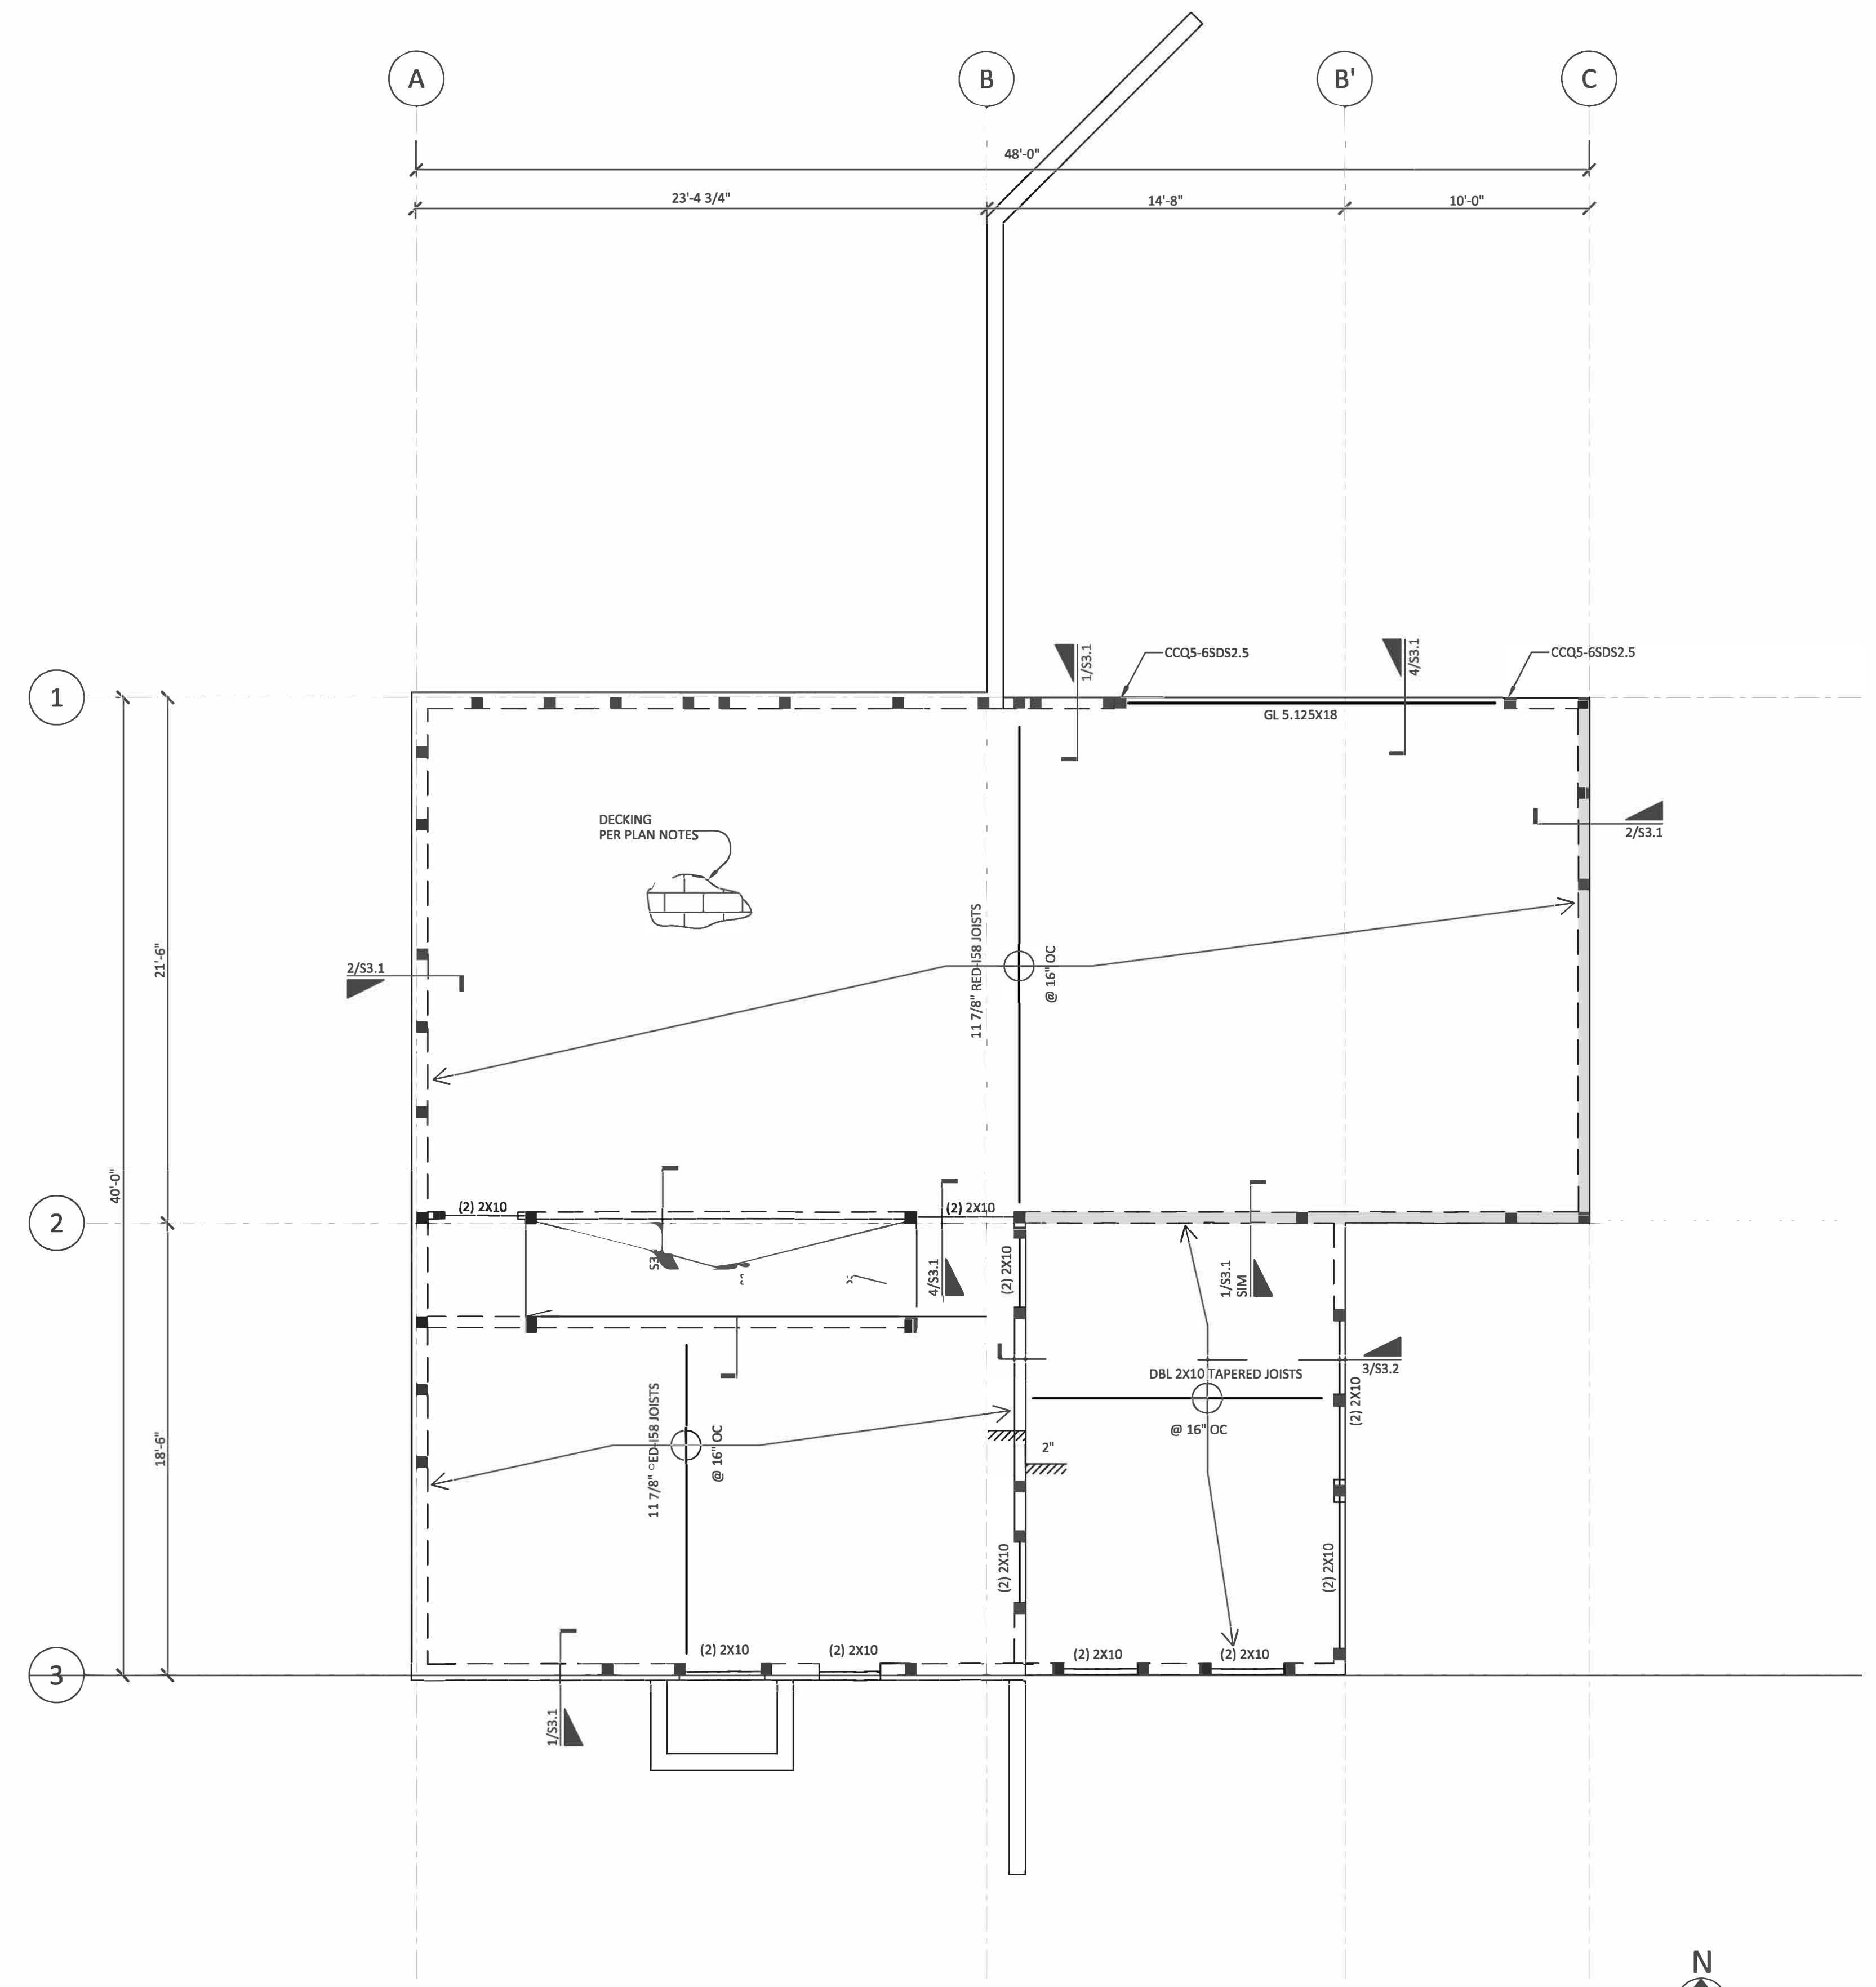

1 FIRST FLOOR FRAMING PLAN
 SCALE: 1/4" = 1'-0"

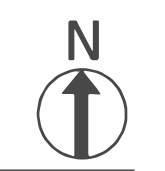



MERRELL DESIGN SERVICES PLLC
 Nine Mile Falls, Washington 99026
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 TJ@MDSstructural.com

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CHESHIRE

COMPANY:
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JOBSITE ADDRESS:
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ARCHITECT:
 Formworks Design Build
 7434 SE 71st St
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SHEET TITLE:
SECOND FLOOR FRAMING PLAN

SHEET#:
S2.2

DRAWN: MAF DATE: 08/12/2021 CHECKED: TJM DATE: 08/12/2021

FLOOR FRAMING PLAN NOTES:

- VERIFY LOCATIONS OF NEW COLUMNS, WALLS, OPENINGS, ETC. WITH ARCHITECTURAL DRAWINGS. VERIFY ALL WALL, FLOOR, AND ROOF ELEVATIONS WITH ARCHITECTS DRAWINGS.
- COORDINATE FRAMING WITH ALL MECHANICAL, HVAC, SPRINKLER, PLUMBING, AND ELECTRICAL DRAWINGS.
- ALL WOOD EXPOSED TO WEATHER, OR IN CONTACT WITH CONCRETE, OR WITHIN 8" OF GRADE SHALL BE PRESSURE TREATED.
- PROVIDE SOLID BLOCKING BETWEEN FLOOR JOISTS/TRUSSES OVER ALL BEARING WALLS AND SHEAR WALLS.
- ALL HORIZONTAL STRAP TIES INDICATED ON PLAN SHALL BE ALIGNED WITH TOP PLATE OR BEAM AND BE CENTERED OVER THE JOINT BETWEEN ADJOINING ELEMENTS. REFERENCE THE STRAP MANUFACTURER FOR FASTENER SIZE AND SPACING.
- ALL JOIST HANGERS SHALL BE SIMPSON TOP FLANGE BEARING JB TYPE, UNO. GLULAM HANGERS SHALL BE HGLTV UNLESS NOTED OTHERWISE ON PLAN. ENGINEERED "T" JOIST HANGERS SHALL BE DESIGNED AND SUPPLIED BY THE JOIST SUPPLIER.
- ALL HEADERS SHALL BE MINIMUM (2) 2X10 FOR SPANS UP TO 3 FEET AND MINIMUM 5 1/8 X 12 GLULAM FOR SPANS UP TO 6 FEET, UNLESS INDICATED OTHERWISE. ALL HEADERS AND BEAMS SHALL BE SUPPORTED BY A MINIMUM OF (2) TRIMMER AND (1) KING STUD. REFERENCE THE PLANS FOR LARGER POSTS OR ADDITIONAL TRIMMERS WHERE REQUIRED. TRIMMER STUDS OR POSTS SHALL BE CONTINUOUS TO THE FOUNDATION UNLESS SUPPORTED BY TRANSFER BEAM.
- REFERENCE SHEAR WALL SCHEDULE FOR SHEAR WALL TYPES AND CONSTRUCTION REQUIREMENTS.
- REFERENCE THE STRUCTURAL GENERAL NOTES FOR DESIGN CRITERIA, LEGEND, AND ABBREVIATIONS.
- PROVIDE JOIST/TRUSS BRIDGING PER MANUFACTURERS REQUIREMENTS FOR ALL ENGINEERED JOISTS AND TRUSSES.
- PROVIDE DOUBLE JOISTS OR DOUBLE BLOCKING AROUND ENTIRE PERIMETER OF OPENINGS GREATER THAN ONE JOIST BAY. PROVIDE DOUBLE JOIST HANGER AT ENDS OF BLOCKING.
- FLOOR SHEATHING SHALL BE AS FOLLOWS:


FLOOR SHEATHING			
SIZE	EDGE NAILING	FIELD NAILING	SPAN RATING
23/32"	0.131 X 2.5" @ 6" OC	0.131 X 2.5" @ 12" OC	24 OC

NOTES:


- ALL SHEATHING SHALL BE APA-RATED.
- LAY SHEATHING WITH FACE GRAIN PERPENDICULAR TO SUPPORTS.
- STAGGER ALL SHEATHING PANEL END JOINTS.
- PROVIDE 1/8" GAP BETWEEN PANEL ENDS AND EDGES.
- FLOOR SHEATHING SHALL BE STURD-I-FLOOR GRADE.

- STRUCTURAL WALL STUD SIZES ARE AS FOLLOWS. REFERENCE THE GENERAL NOTES FOR LUMBER SPECIES:

STRUCTURAL WALL STUD SIZES (minimum)			
Wall	Stud Size	Spacing	Grade
Interior Bearing	2x4	16" OC	no 2
Exterior	2x6	16" OC	no 2

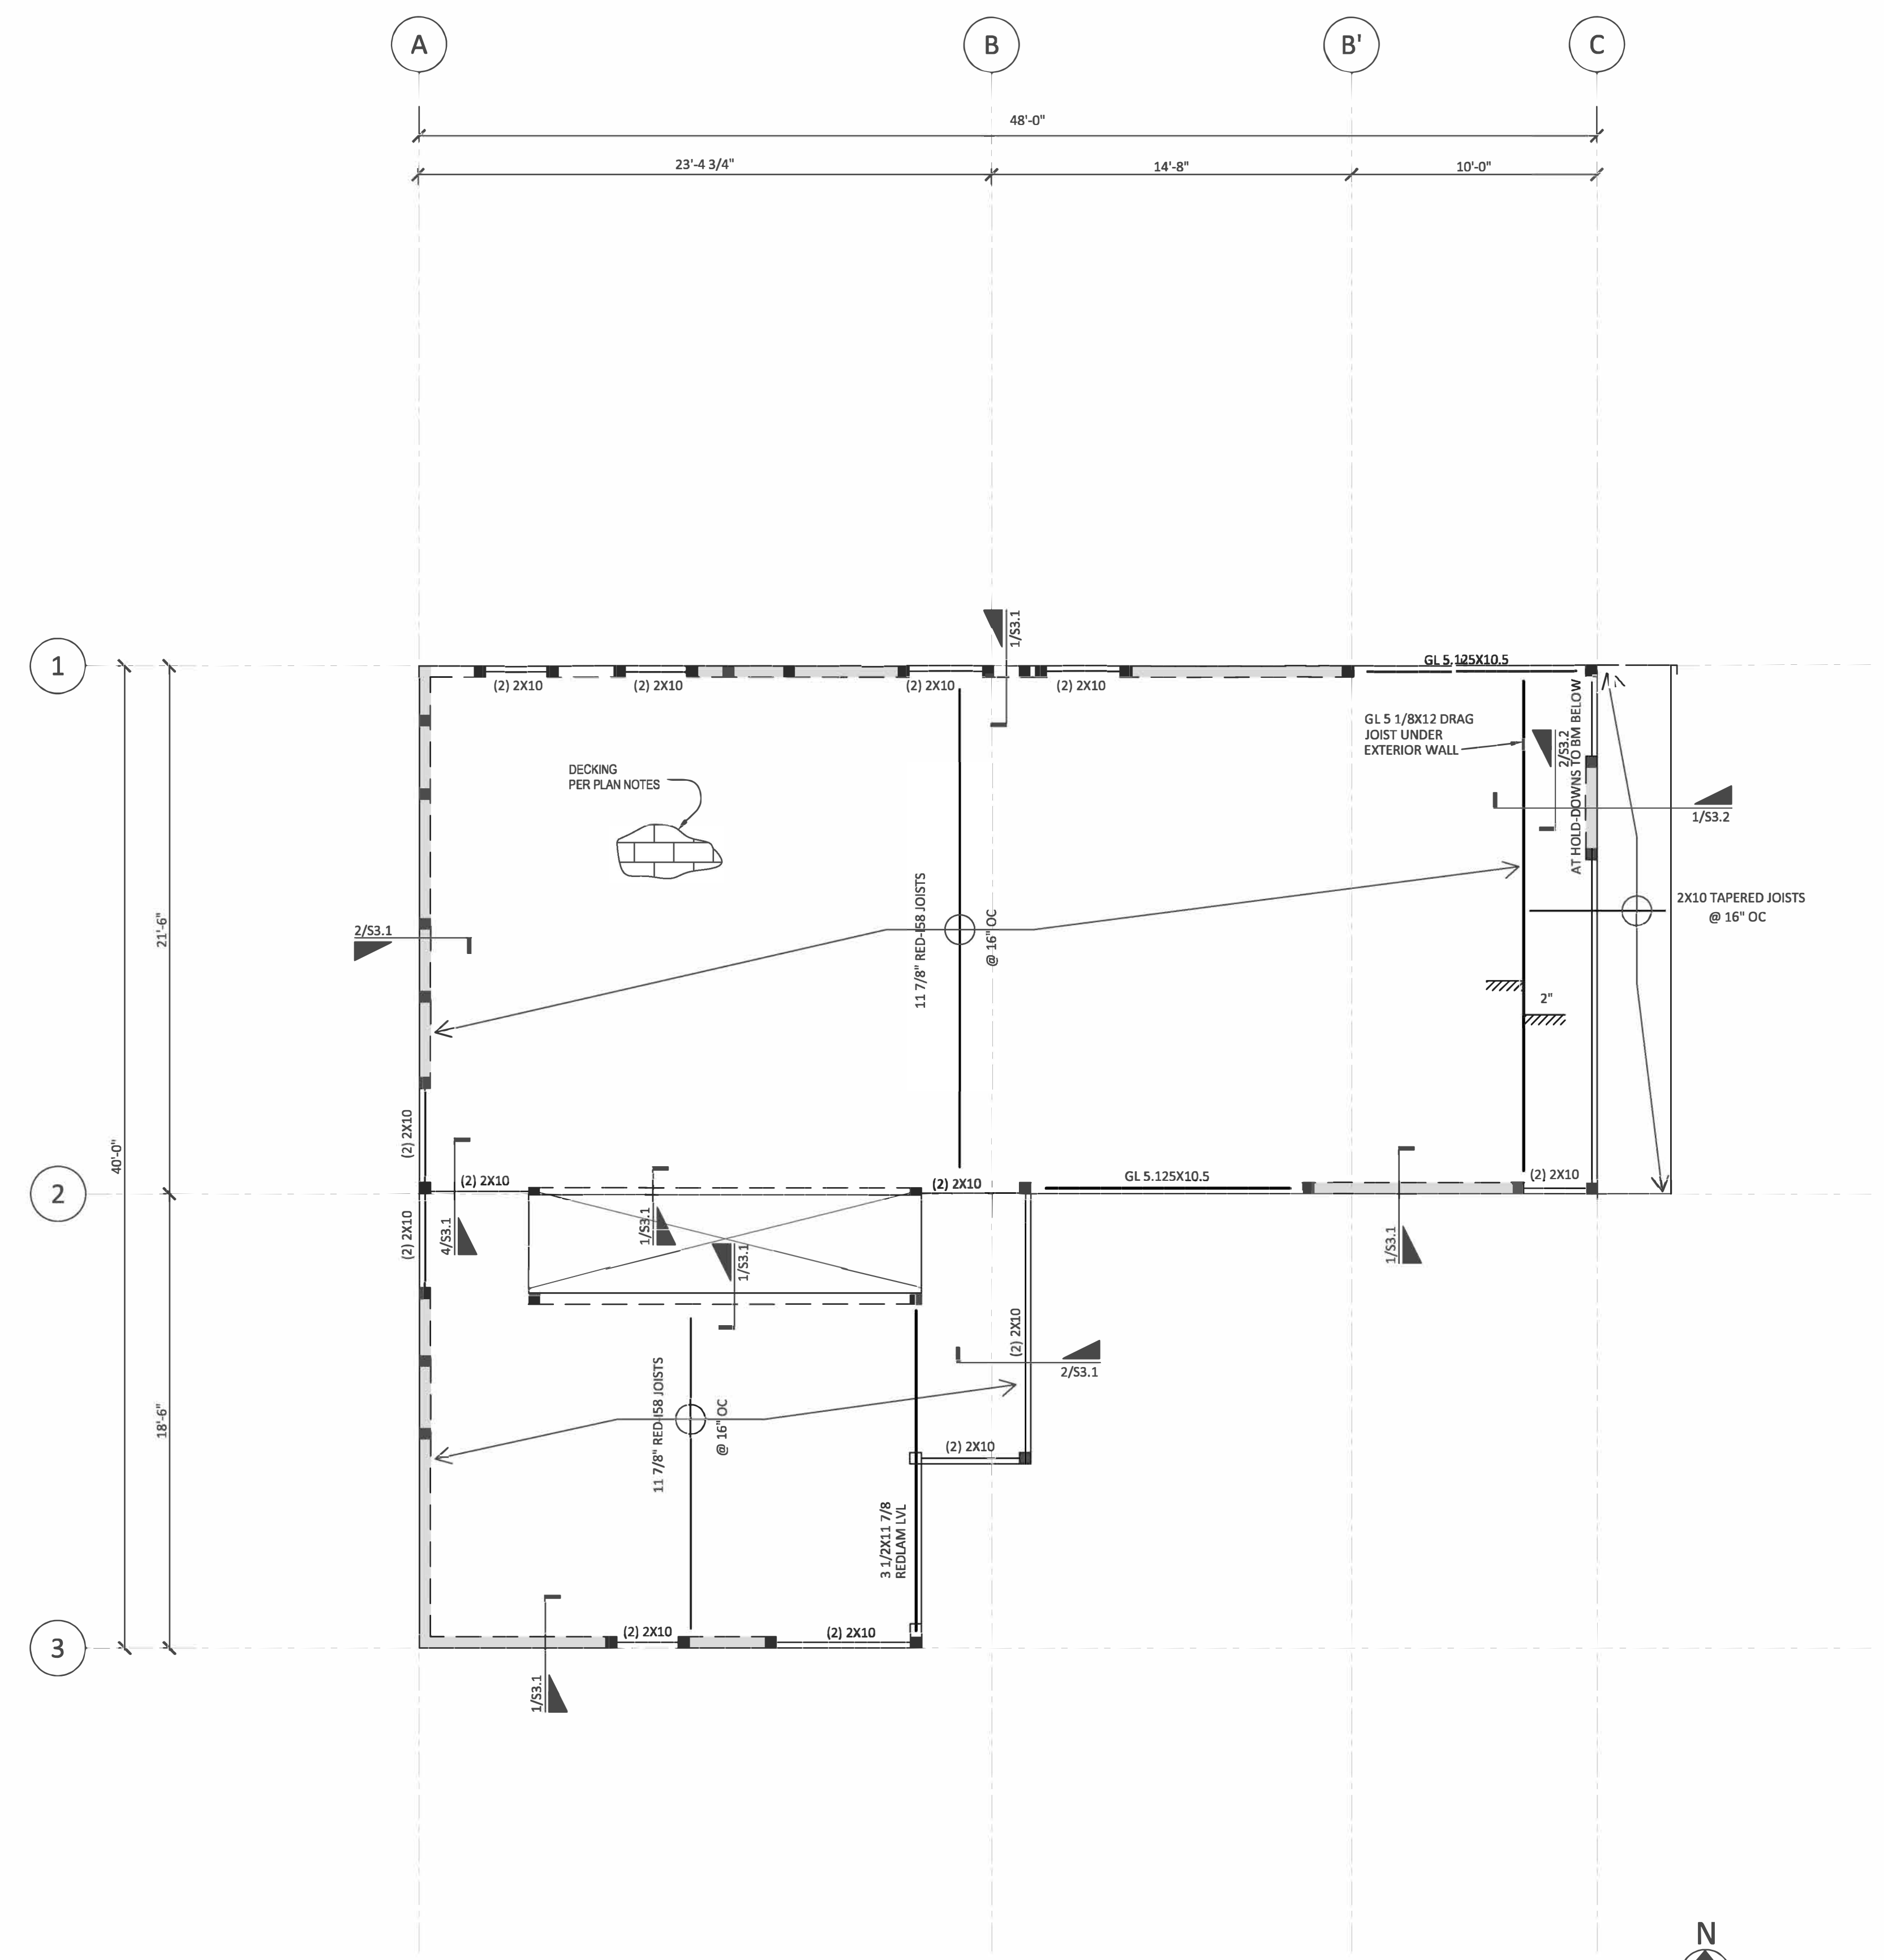

1 SECOND FLOOR FRAMING PLAN
 SCALE: 1/4" = 1'-0"

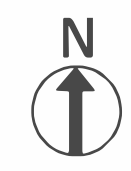



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JOB#
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SHEET TITLE:
 ROOF FRAMING PLAN

SHEET#:
S2.3

SCALE:
 AS SHOWN

DRAWN: DATE: CHECKED: DATE:
 MAF 08/12/2021 TIM 08/12/2021


ROOF FRAMING PLAN NOTES:

- VERIFY LOCATIONS OF NEW COLUMNS, WALLS, OPENINGS, ETC. WITH ARCHITECTURAL DRAWINGS. VERIFY ALL WALL, FLOOR, AND ROOF ELEVATIONS WITH ARCHITECTS DRAWINGS.
- COORDINATE FRAMING WITH ALL MECHANICAL, HVAC, SPRINKLER, PLUMBING, AND ELECTRICAL DRAWINGS.
- PROVIDE MINIMUM SIMPSON H2.5A HURRICANE TIES AT ALL ROOF JOISTS/TRUSSES UNLESS HEAVIER TIES ARE INDICATED ON PLAN.
- PROVIDE SOLID BLOCKING BETWEEN ROOF JOISTS/TRUSSES OVER ALL BEARING WALLS AND SHEAR WALLS.
- ALL HORIZONTAL STRAP TIES INDICATED ON PLAN SHALL BE ALIGNED WITH TOP PLATE OR BEAM AND BE CENTERED OVER THE JOINT BETWEEN ADJOINING ELEMENTS. REFERENCE THE STRAP MANUFACTURER FOR FASTENER SIZE AND SPACING.
- ALL JOIST HANGERS SHALL BE SIMPSON TOP FLANGE BEARING JB TYPE, UNO. GLULAM HANGERS SHALL BE HGLTV UNLESS NOTED OTHERWISE ON PLAN. ENGINEERED "I" JOIST HANGERS SHALL BE DESIGNED AND SUPPLIED BY THE JOIST SUPPLIER.
- ALL HEADERS SHALL BE MINIMUM (2) 2X10 FOR SPANS UP TO 3 FEET AND MINIMUM 5 1/8 X 12 GLULAM FOR SPANS UP TO 6 FEET, UNLESS INDICATED OTHERWISE. ALL HEADERS AND BEAMS SHALL BE SUPPORTED BY A MINIMUM OF (2) TRIMMER AND (1) KING STUD REFERENCE THE PLANS FOR LARGER POSTS OR ADDITIONAL TRIMMERS WHERE REQUIRED. TRIMMER STUDS OR POSTS SHALL BE CONTINUOUS TO THE FOUNDATION UNLESS SUPPORTED BY TRANSFER BEAM.
- REFERENCE SHEAR WALL SCHEDULE FOR SHEAR WALL TYPES AND CONSTRUCTION REQUIREMENTS.
- REFERENCE THE STRUCTURAL GENERAL NOTES FOR DESIGN CRITERIA, LEGEND, AND ABBREVIATIONS.
- PROVIDE JOIST/TRUSS BRIDGING PER MANUFACTURERS REQUIREMENTS FOR ALL ENGINEERED JOISTS AND TRUSSES.
- ROOF SHEATHING SHALL BE AS FOLLOWS:


ROOF SHEATHING			
SIZE	EDGE NAILING	FIELD NAILING	SPAN RATING
19/32"	0.131 X 2.5" @ 6" OC	0.131 X 2.5" @ 12" OC	32/16

NOTES:

- ALL SHEATHING SHALL BE APA RATED.
- LAY SHEATHING WITH FACE GRAIN PERPENDICULAR TO SUPPORTS.
- STAGGER ALL SHEATHING PANEL END JOINTS
- PROVIDE 1/8" GAP BETWEEN PANEL ENDS AND EDGES
- ROOF SHEATHING SHALL BE C-D GRADE

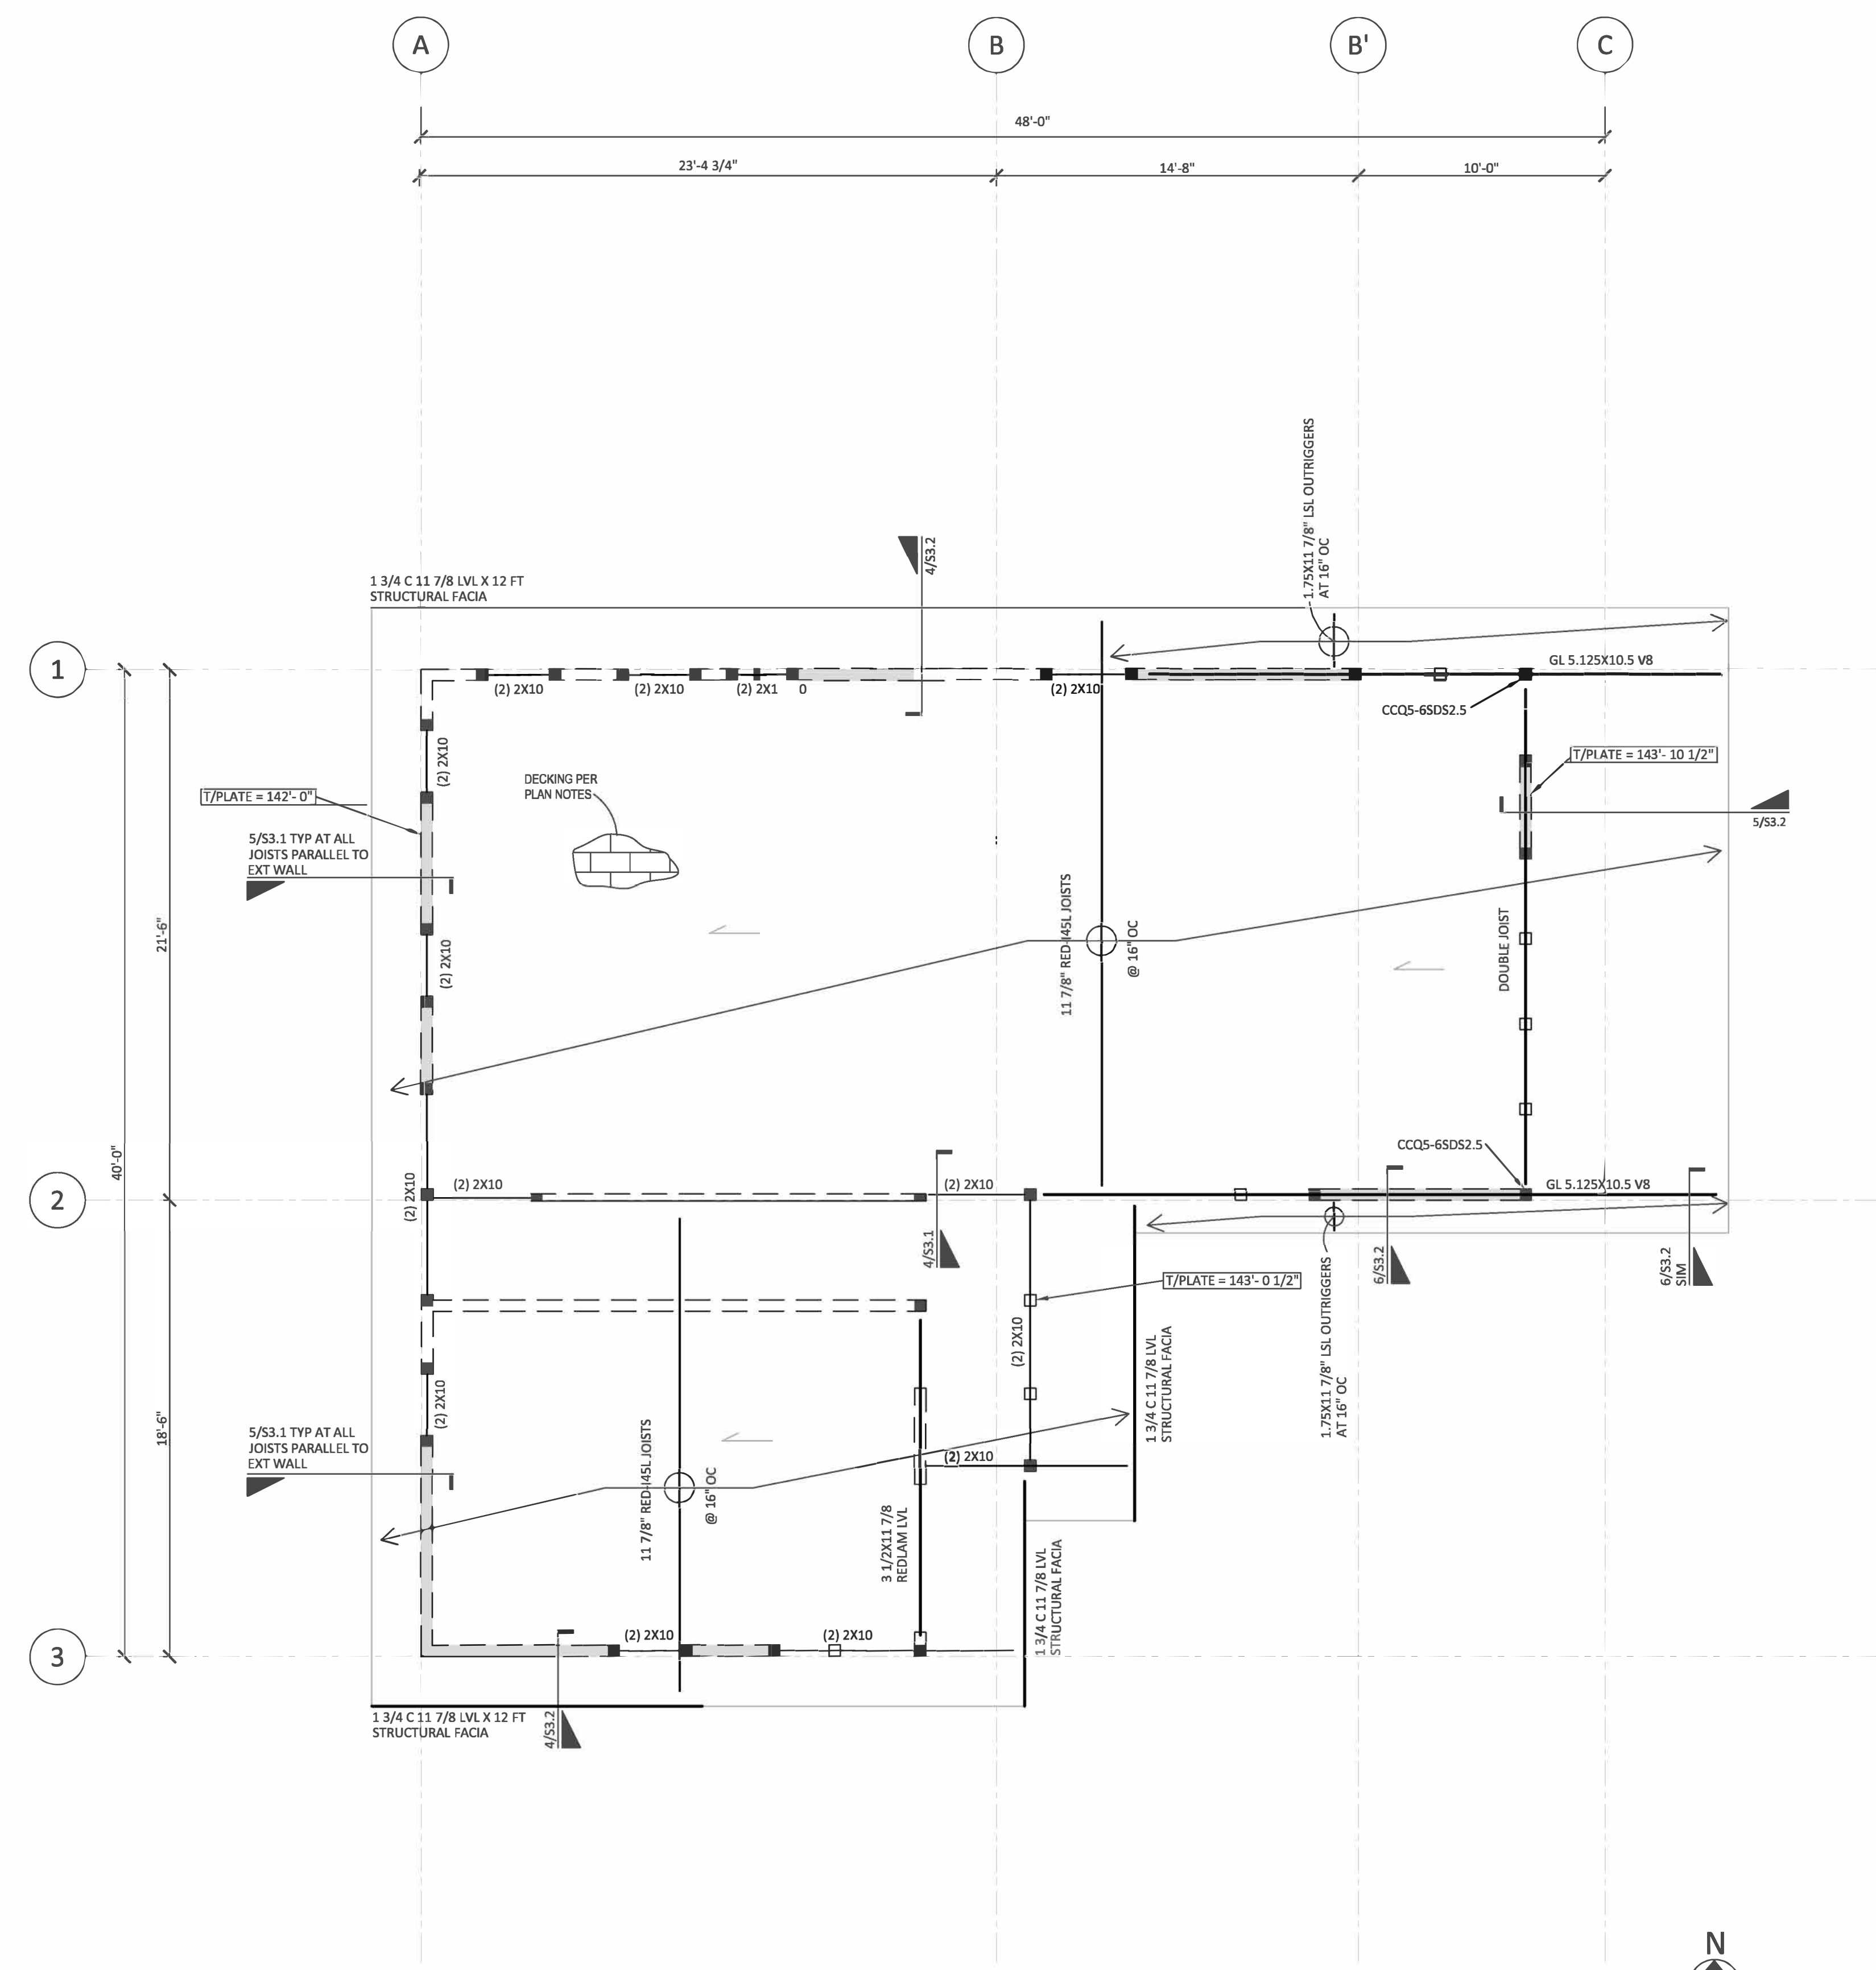

1 ROOF FRAMING PLAN
 SCALE: 1/4" = 1'-0"

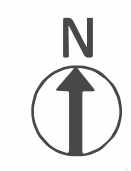



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ARCHITECT:
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 98040

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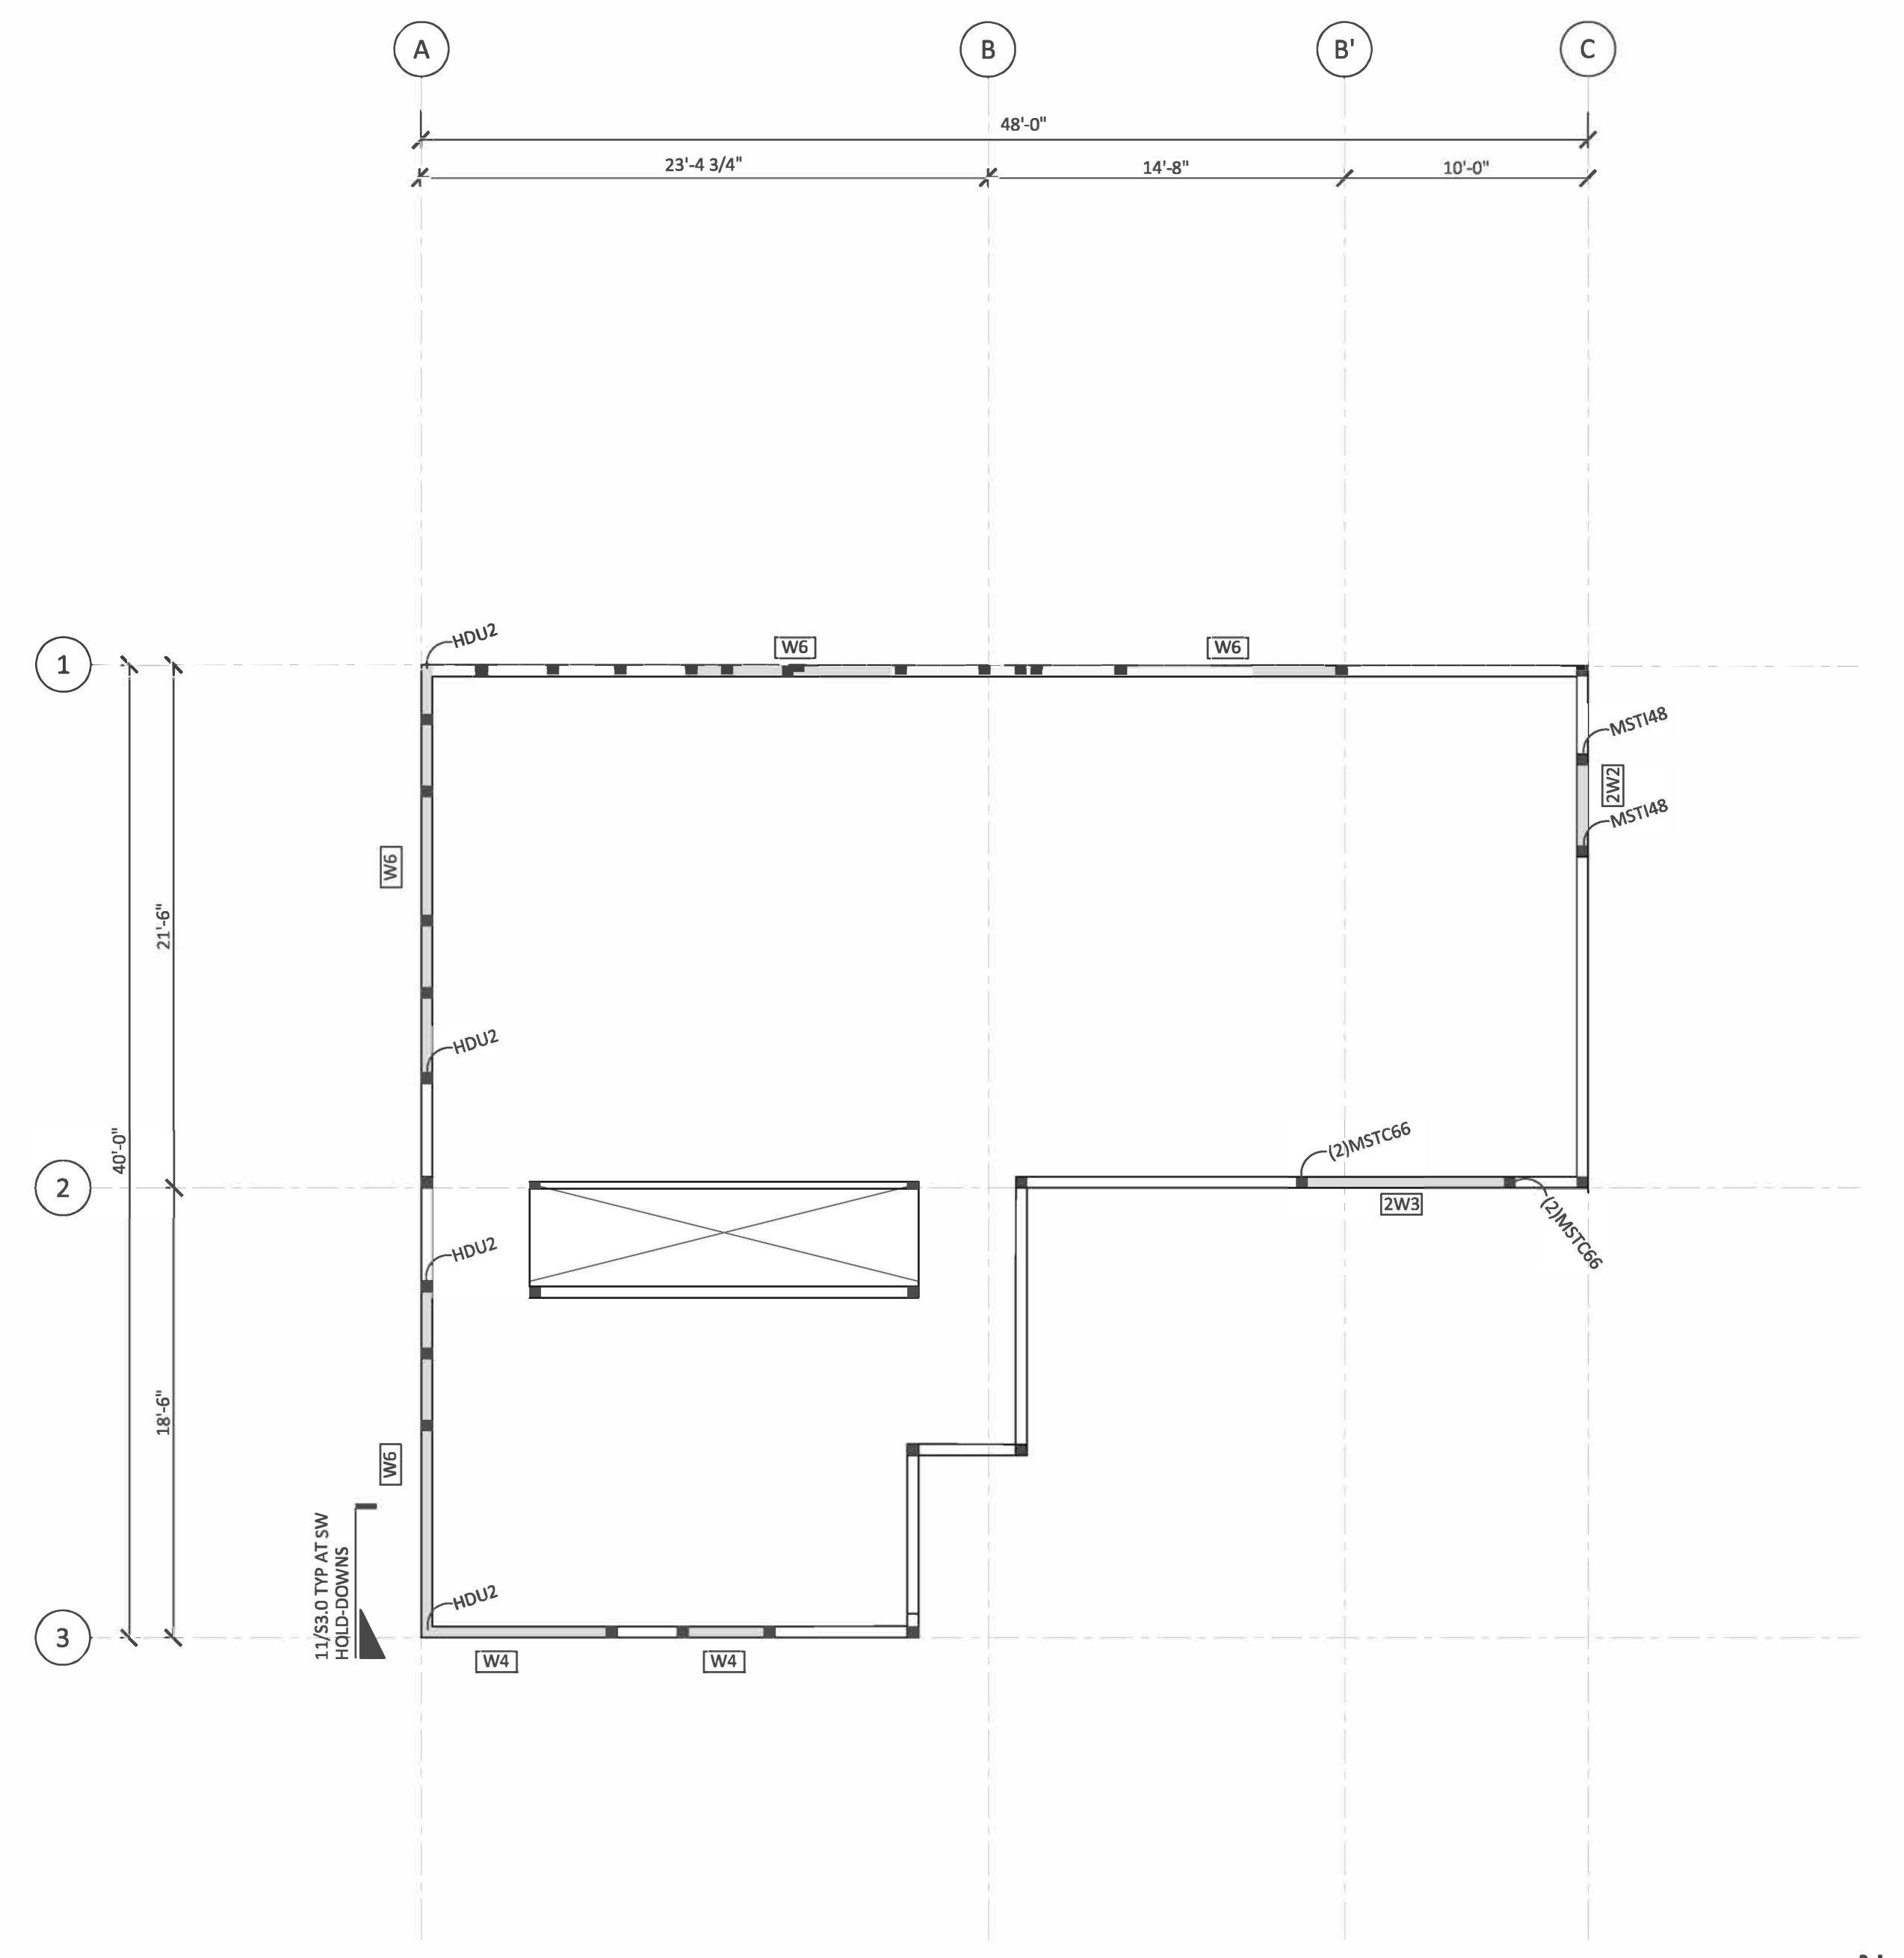
JOB#
2020

SHEET TITLE:
FIRST & SECOND FLOOR STUD PLANS


SHEET#:
S2.4 SCALE: AS SHOWN

DRAWN: DATE: CHECKED: DATE:
 MAF 08/12/2021 TJM 08/12/2021


- STUD AND SHEAR WALL PLAN NOTES:**
1. ALL EXTERIOR WALLS AND INTERIOR BEARING WALLS SHALL BE PER THE PLANS OR STUD WALL SCHEDULE, UNLESS NOTED OTHERWISE. STUDS SHALL ALIGN NOMINALLY FLOOR TO FLOOR WITH STUDS, JOISTS, AND TRUSSES. ATTACH SILL PLATES TO CONCRETE, RIM BOARD, OR TOP PLATE PER SCHEDULE, UNO IN SHEAR WALL SCHEDULE.
 2. REFERENCE THE STRUCTURAL GENERAL NOTES FOR DESIGN CRITERIA, LUMBER GRADES, LEGEND, AND ABBREVIATIONS.
 3. PROVIDE MINIMUM BLOCKING AT 5'-0" OC MAX FOR ALL BEARING AND EXTERIOR WALLS. REFER TO SHEAR WALL SCHEDULE FOR ADDITIONAL BLOCKING REQUIREMENTS.
 4. PROVIDE MINIMUM SILL ANCHORAGE OF 5/8" X 7" EMBED BOLTS AT 48" OC UNLESS NOTED OTHERWISE ON SHEARWALL SCHEDULE. BOLTS SHALL BE GALVANIZED AT PRESSURE TREATED SILL PLATES.
 5. FOR SHEAR WALL STRAPS AND ATTACHMENT REQUIREMENTS, REFERENCE THE SHEAR WALL SCHEDULE.
 6. INDICATES HOLD-DOWN TYPE, REFERENCE HOLD-DOWN SCHEDULE.
 7. SEE DETAIL 8/S3.1 FOR STANDARD SHEAR WALL CONSTRUCTION AND HOLD-DOWN STRAP ATTACHMENT.



1 FIRST FLOOR STUD FRAMING PLAN
 SCALE: 3/16" = 1'-0"

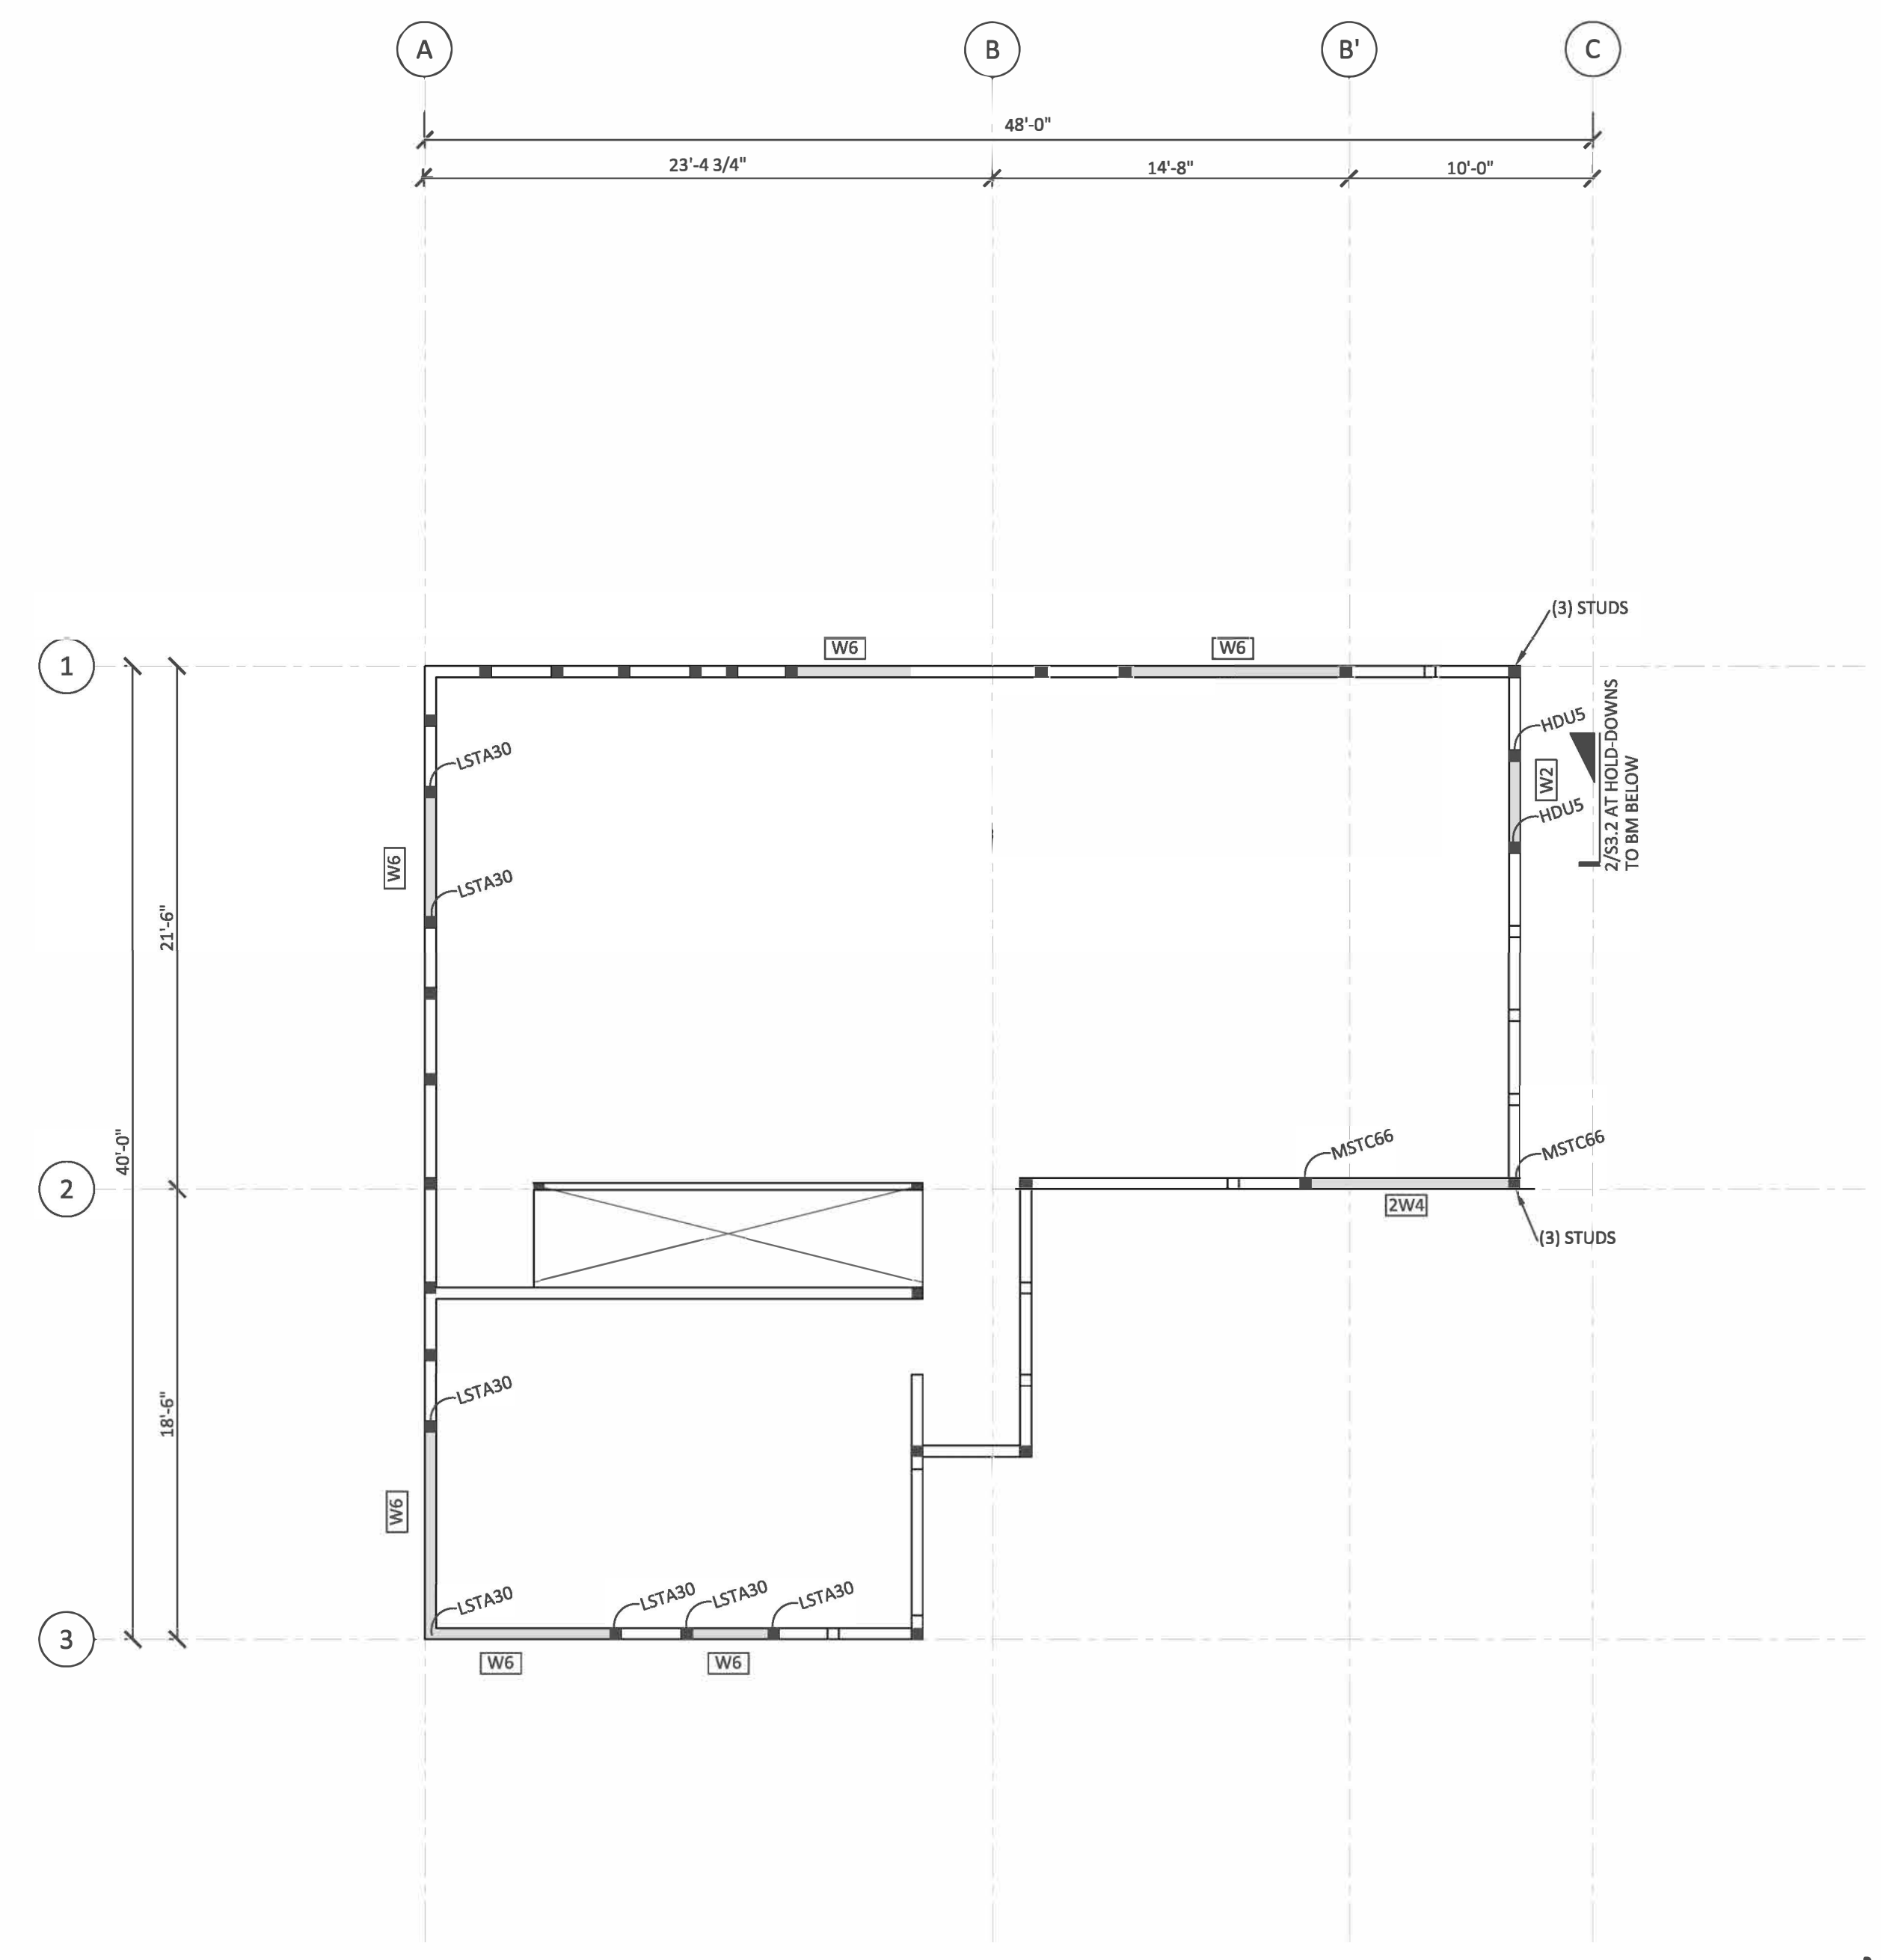

2 SECOND FLOOR STUD FRAMING PLAN
 SCALE: 3/16" = 1'-0"

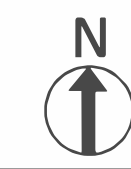

PROJECT:
CHESHIRE

COMPANY:
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MERCER ISLAND, WA 98040

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98040


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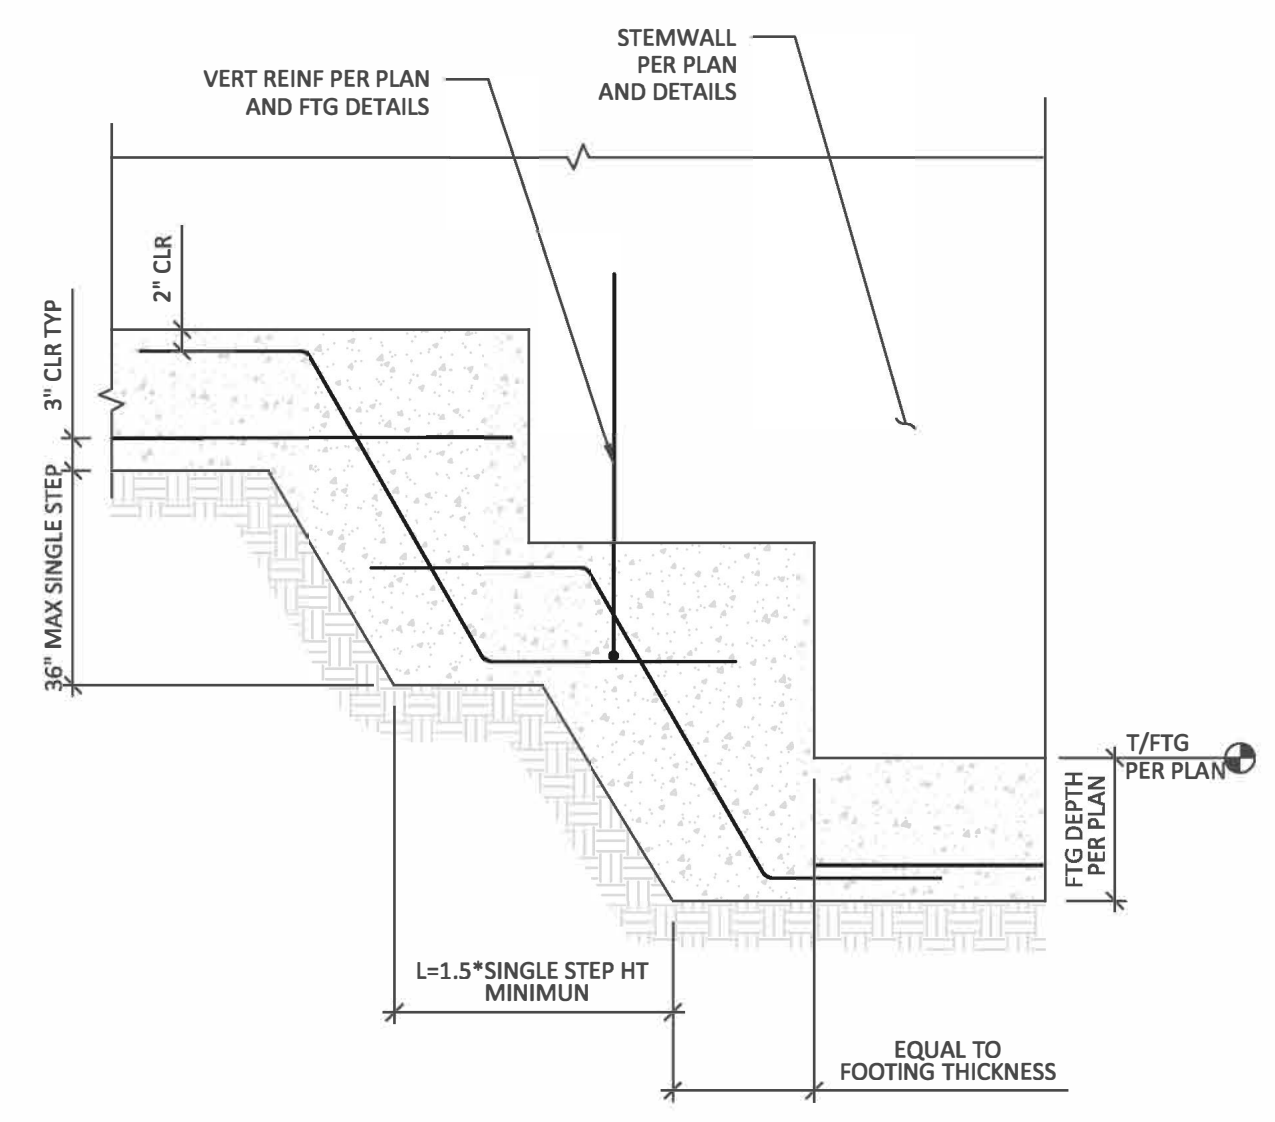
JOB#
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SHEET TITLE:
DETAILS


SHEET#: S3.0

SCALE: AS SHOWN

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DATE: 08/12/2021

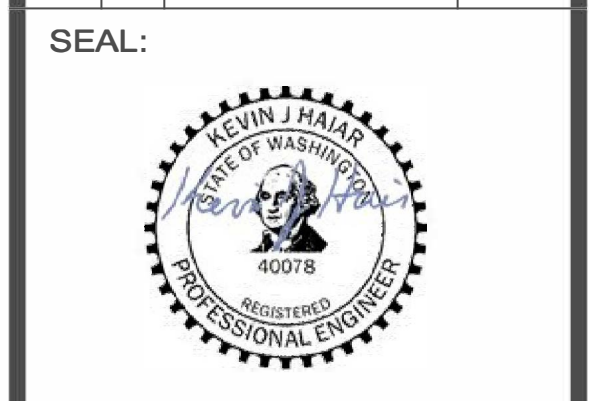


10 STANDARD STEPPED FOOTING DETAIL
SCALE: 3/4" = 1'- 0"

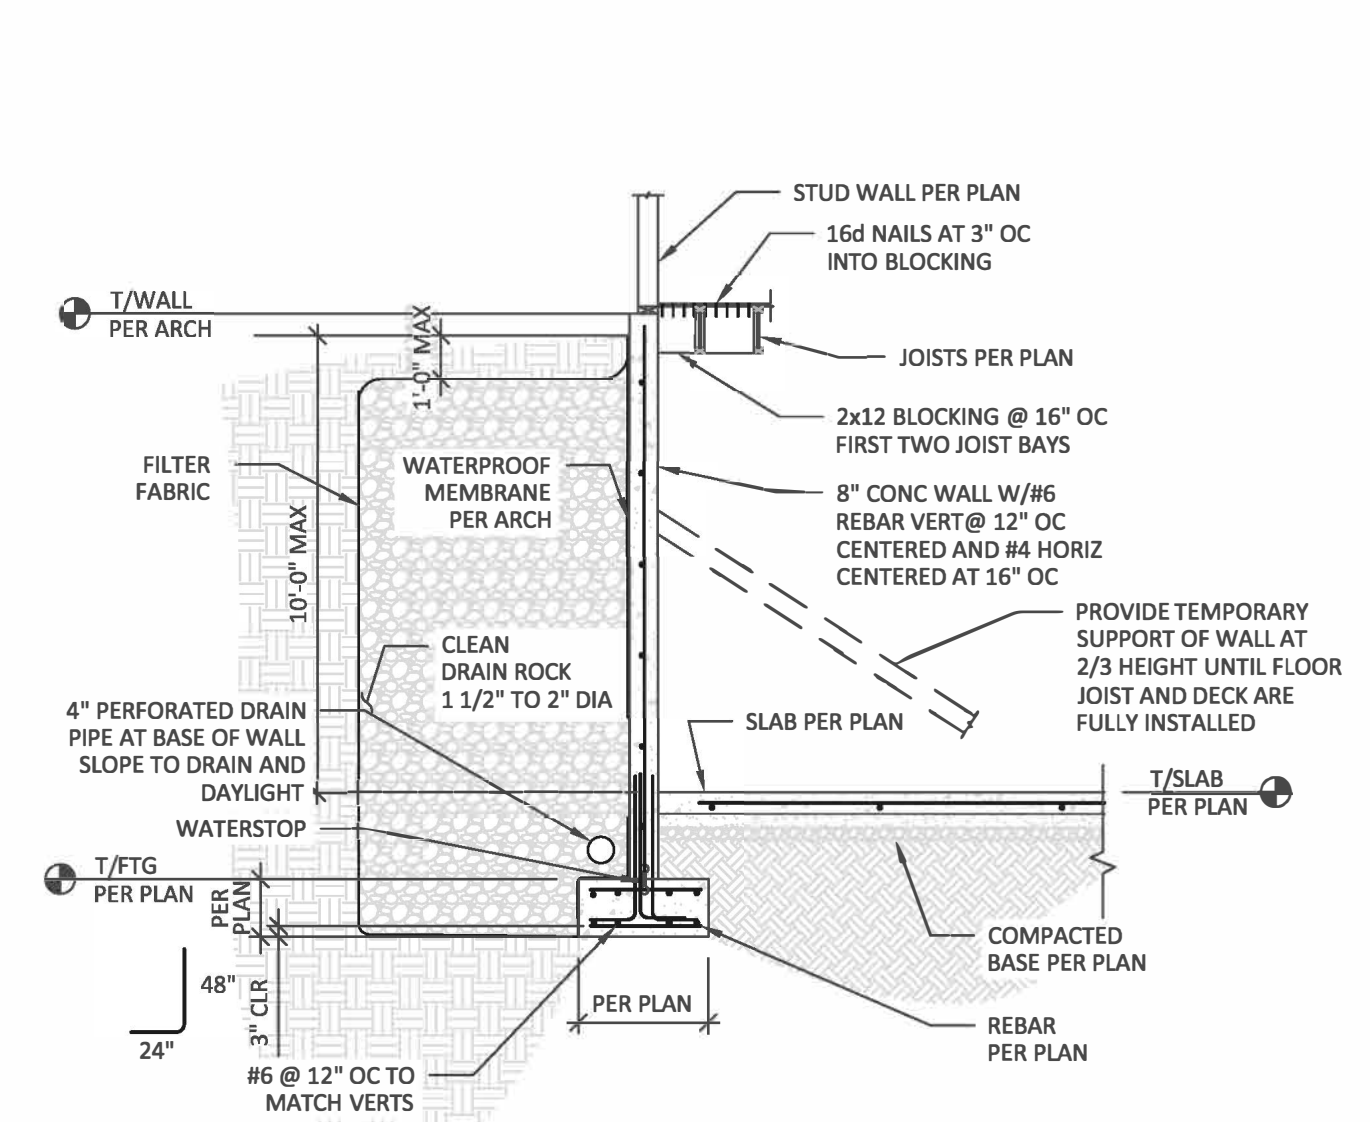

NOTE:
JOIST PERPENDICULAR TO WALL AT SIMILAR CONDITION.


7 BASEMENT WALL AND FOOTING
SCALE: 1/4" = 1'- 0"

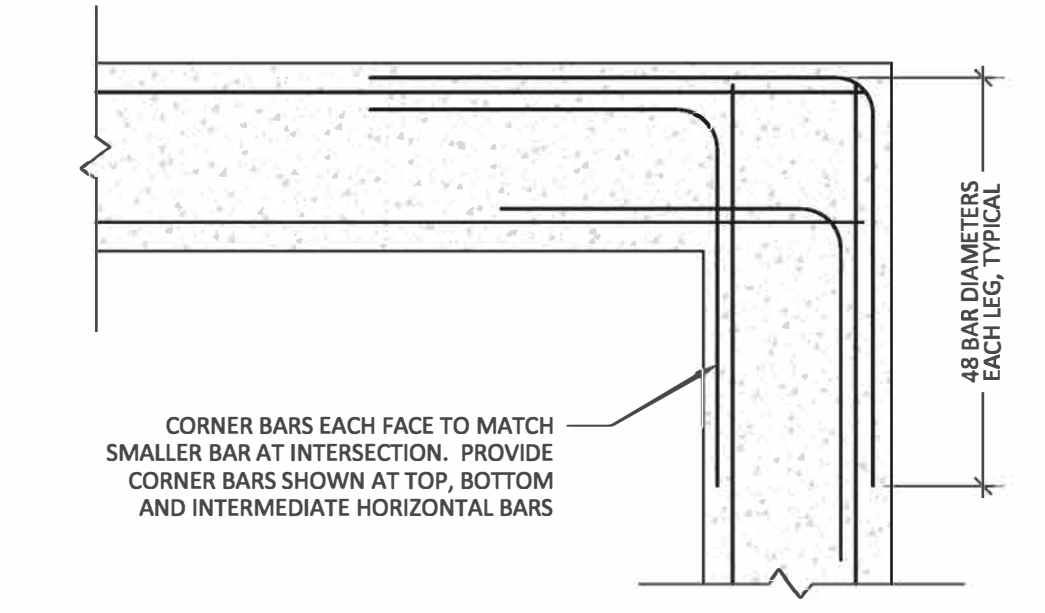


- NOTES:**
- WHERE 90 DEGREE HOOKS ARE SCHEDULED OR DETAILED FOR TOP BARS, CORNER BARS MAY BE OMITTED.
 - MATCH SIZE, LOCATION AND NUMBER OF HORIZONTAL BEAM AND WALL BARS, EXCEPT THAT WHERE THERE ARE MORE THAN 2 TOP OR BOTTOM BARS, ONLY THE INSIDE AND OUTSIDE BARS MUST BE MATCHED.
 - STOP DETAILED REINFORCEMENT 2" SHORT OF FORM.

4 TYPICAL CORNER BARS AT INTERSECTION DETAIL
NOT TO SCALE


1 90° HOOK DIMENSIONS GRADE 60 BARS AND 3000 PSI CONCRETE
NOT TO SCALE

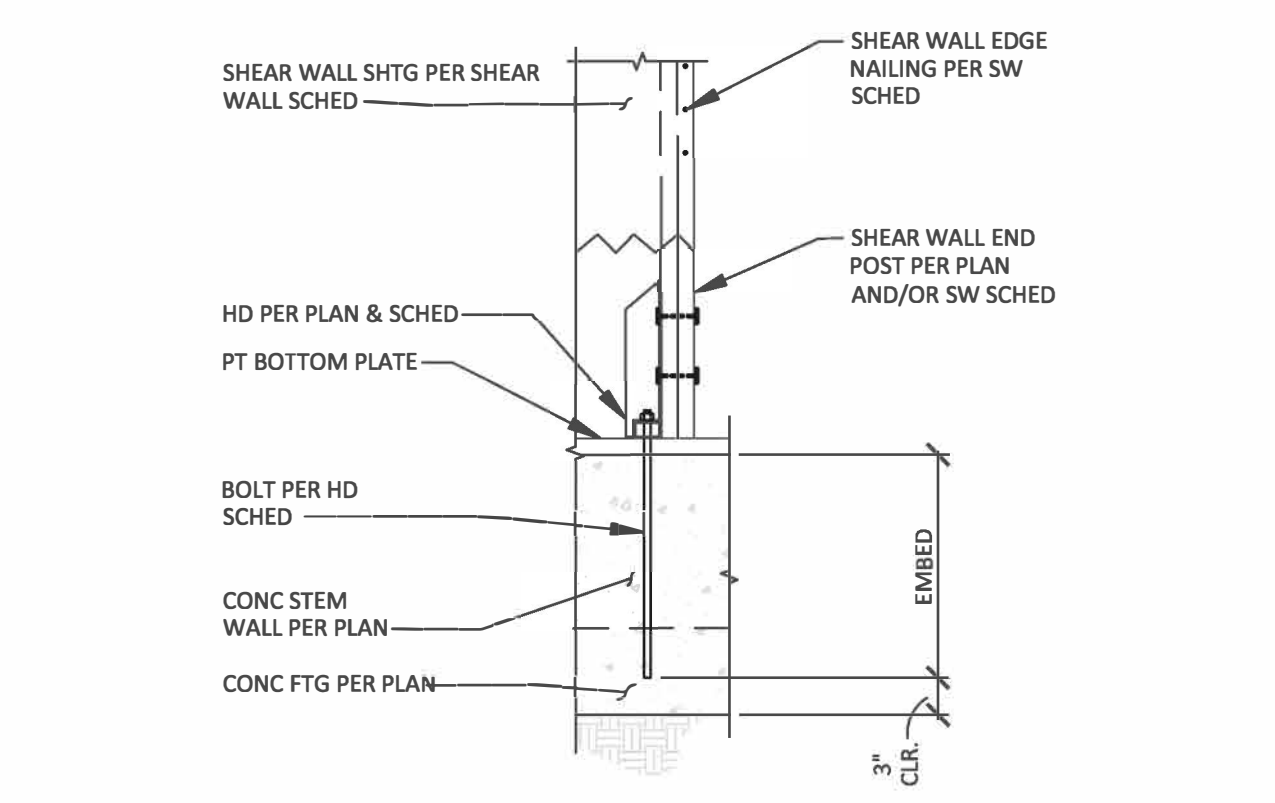

11 TYPICAL HOLD DOWN AT FOUNDATION/CONCRETE
SCALE: 1" = 1'- 0"

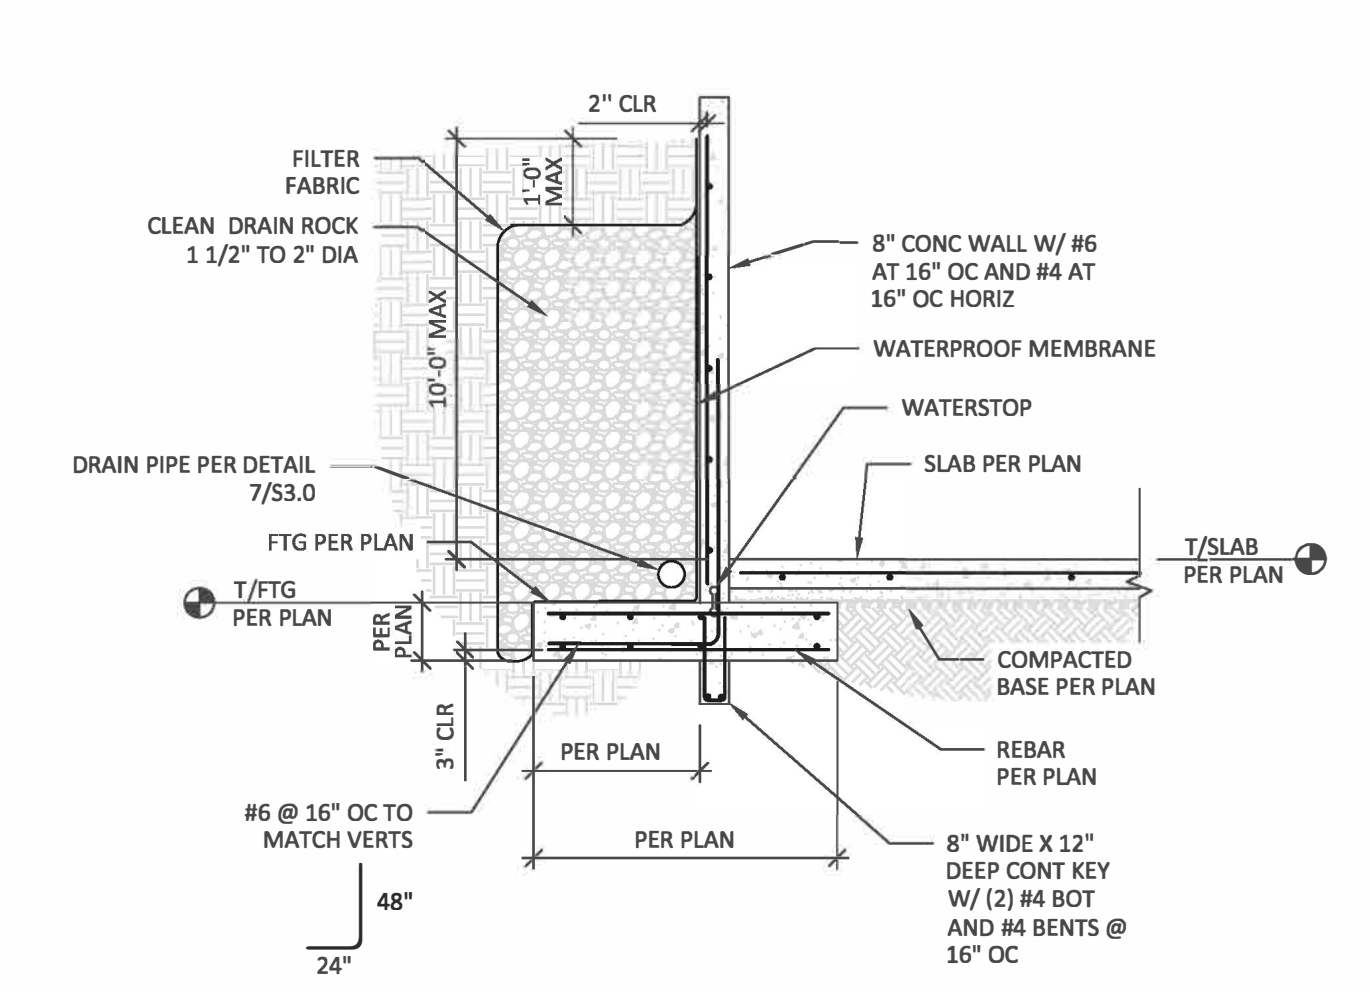

8 SITE RETAINING WALL
SCALE: 1/4" = 1'- 0"

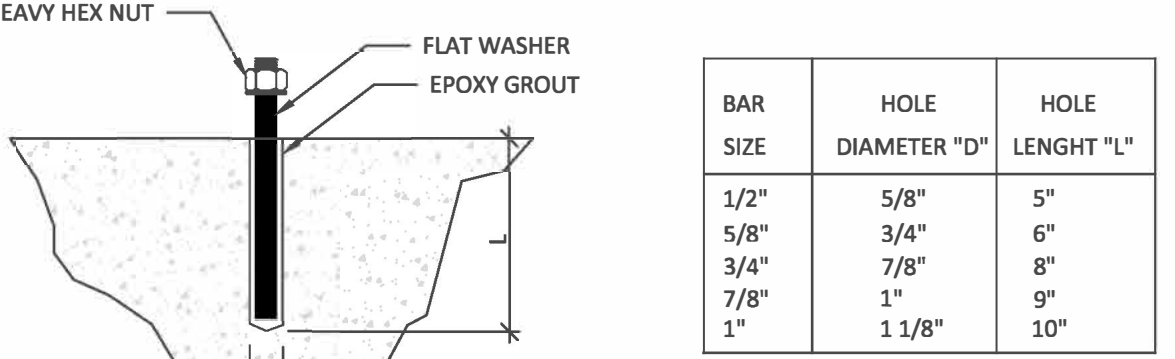


- NOTES:**
- THREADED ROD SHALL BE A36 ROD, NUT & WASHER SHALL BE GALVANIZED AS PER ASTM A153
 - HOLE SHALL BE DRILLED USING ROTARY PERCUSSION DRILL TO FORM ROUGH SURFACE. IF CORE DRILLED, ROUGHEN HOLE SURFACE USING DRILL BIT.
 - HOLE MUST BE THOROUGHLY CLEAN, FREE OF DUST, DEBRIS & STANDING WATER.
 - FOR TEMPERATURES BELOW 70 DEGREES F, EPOXY MAY TAKE 24 HOURS OR LONGER TO CURE. SEE MANUFACTURER'S RECOMMENDATIONS FOR EXACT CURE TIMES. 5. THE EPOXY SHALL BE INJECTED USING THE DUAL COMPONENT CARTRIDGE SYSTEM AS PER INSTRUCTIONS OF THE MANUFACTURER. FOR VERTICAL AND HORIZONTAL APPLICATIONS USE MANUFACTURER'S RECOMMENDED CORRESPONDING PRODUCT.

5 CONCRETE STD THREADED ROD ANCHOR
NOT TO SCALE


BAR SIZE	TOP BARS		OTHERS THAN TOP BARS	
	ld	1.3ld	ld	1.3ld
#3	13"	17"	10"	13"
#4	18"	24"	14"	19"
#5	22"	29"	17"	23"
#6	26"	34"	20"	26"
#7	38"	50"	29"	38"
#8	43"	56"	33"	43"
#9	49"	64"	37"	49"
#10	54"	71"	42"	55"

ld= DEVELOPMENT LENGTH
1.3ld= TENSION LAP SPLICE


2 DEVELOPMENT LENGTH AND TENSION LAP SPLICE LENGTH GRADE 60 BARS AND 3000 PSI CONCRETE
NOT TO SCALE

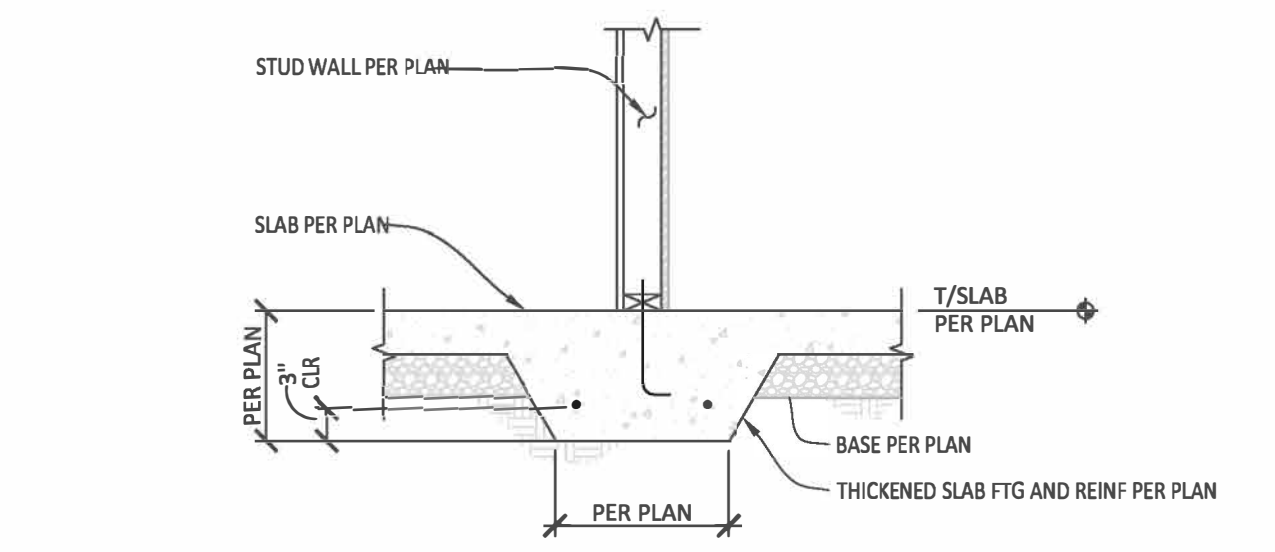


12 INTERIOR THICKENED SLAB FOOTING
SCALE: 3/4" = 1'- 0"

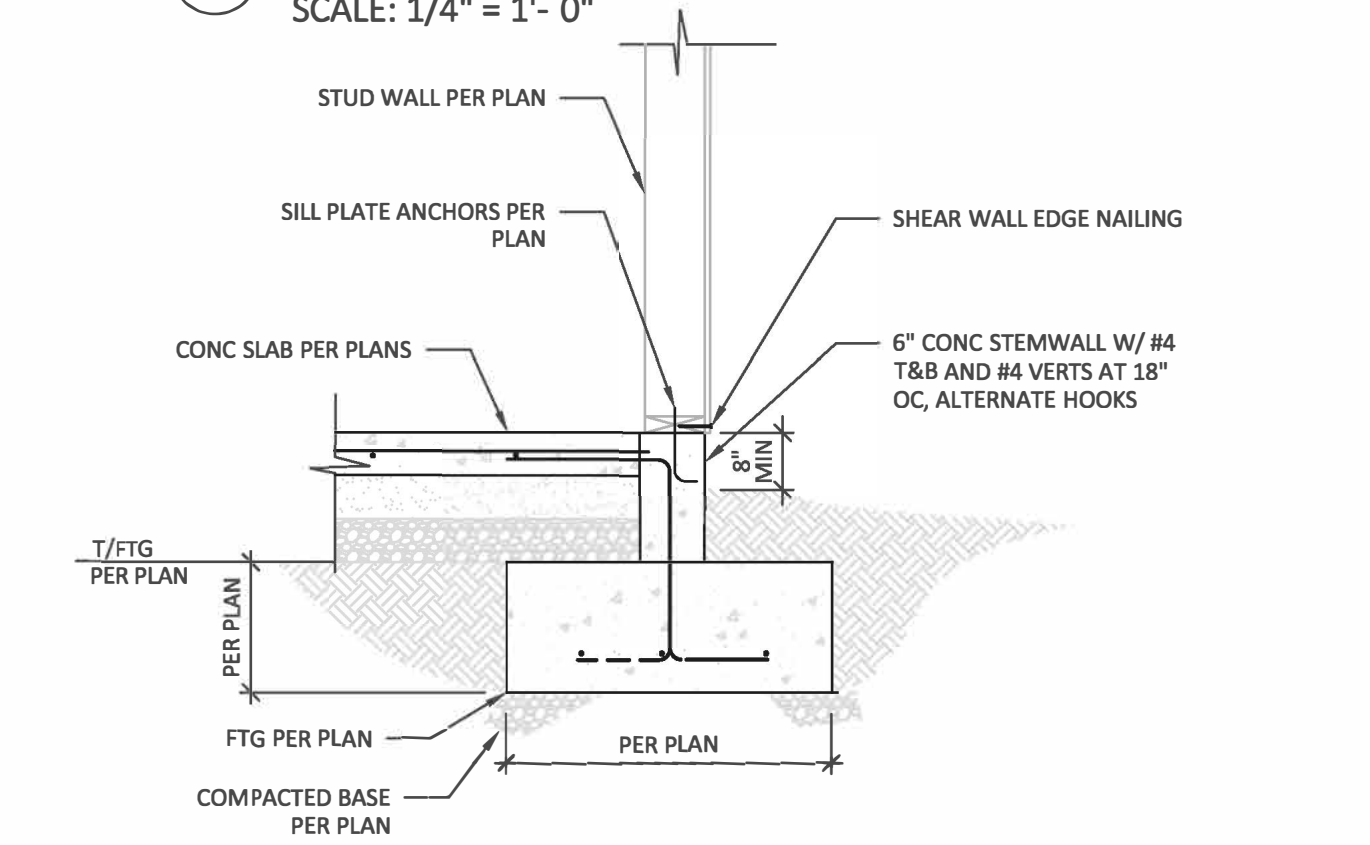

9 TYPICAL EXTERIOR FOOTING
SCALE: 3/4" = 1'- 0"

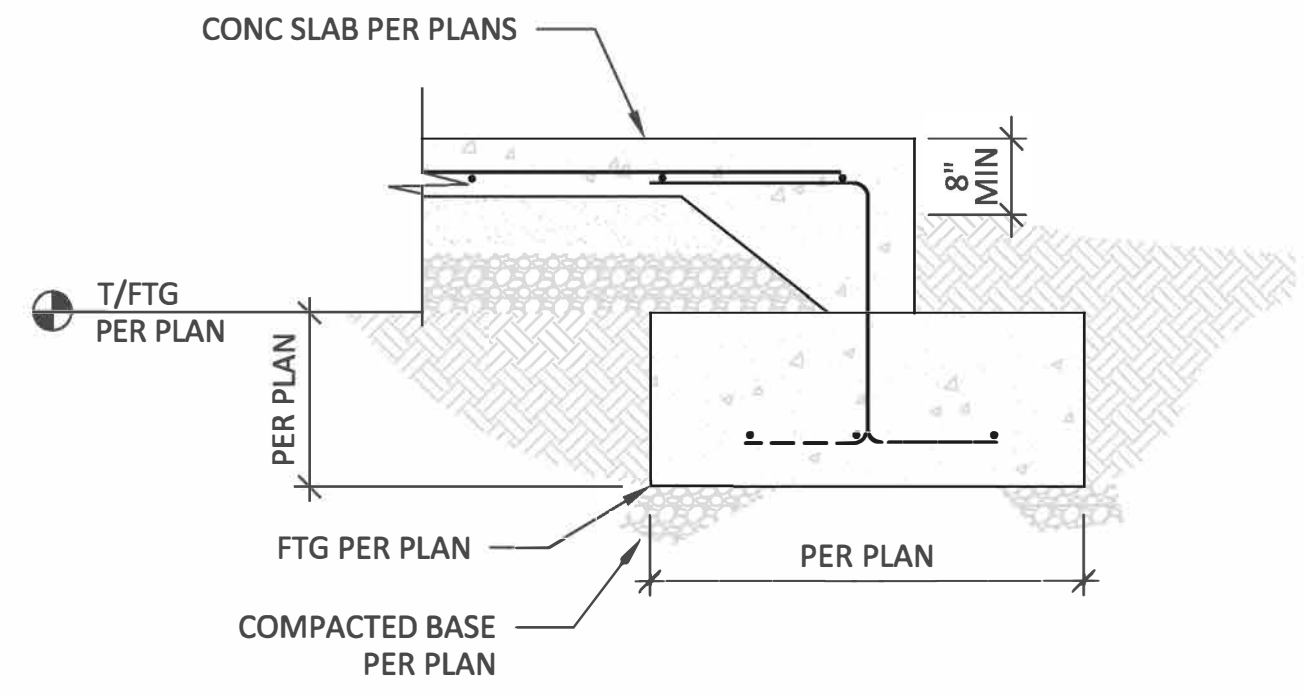

6 SECTION AT SLAB THICKENED EDGE (TYP)
SCALE: 1" = 1'-0"

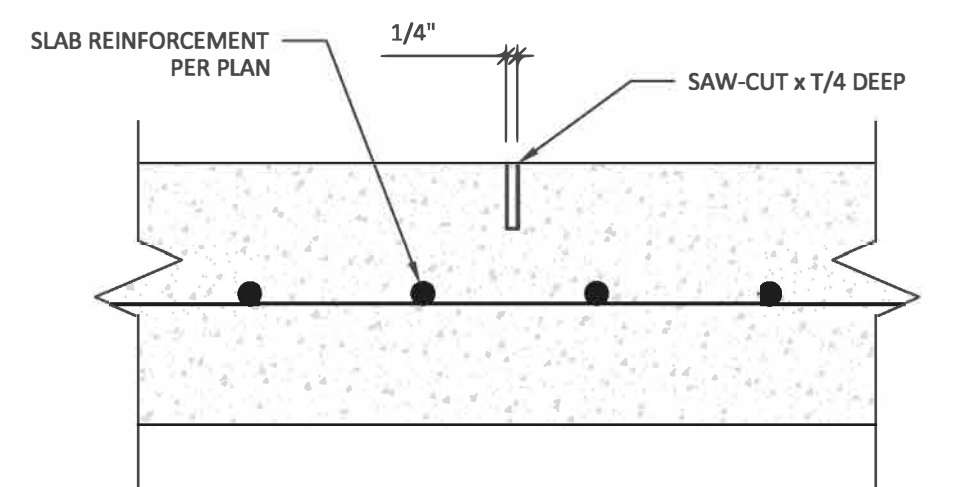

- NOTES:**
- SAW-CUT SHALL BE PERFORMED IN ACCORDANCE WITH ACI 360 AND SHALL BE MADE AS SOON AS POSSIBLE AFTER CONCRETE SETS UP. EARLY ENTRY SOFF-CUT TYPE SAWS SHOULD BE UTILIZED IF POSSIBLE.
 - MAKE INITIAL SAW CUTS ALONG THE SHORT DIRECTION OF THE SLAB FIRST.
 - MAINTAIN MAXIMUM JOINT SPACING OF 10 FEET AND MAXIMUM PANEL ASPECT RATIO OF 1.3 TO 1.0.

3 CONTROL JOINT
NOT TO SCALE



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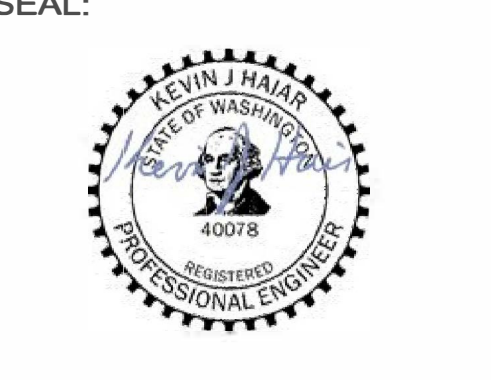
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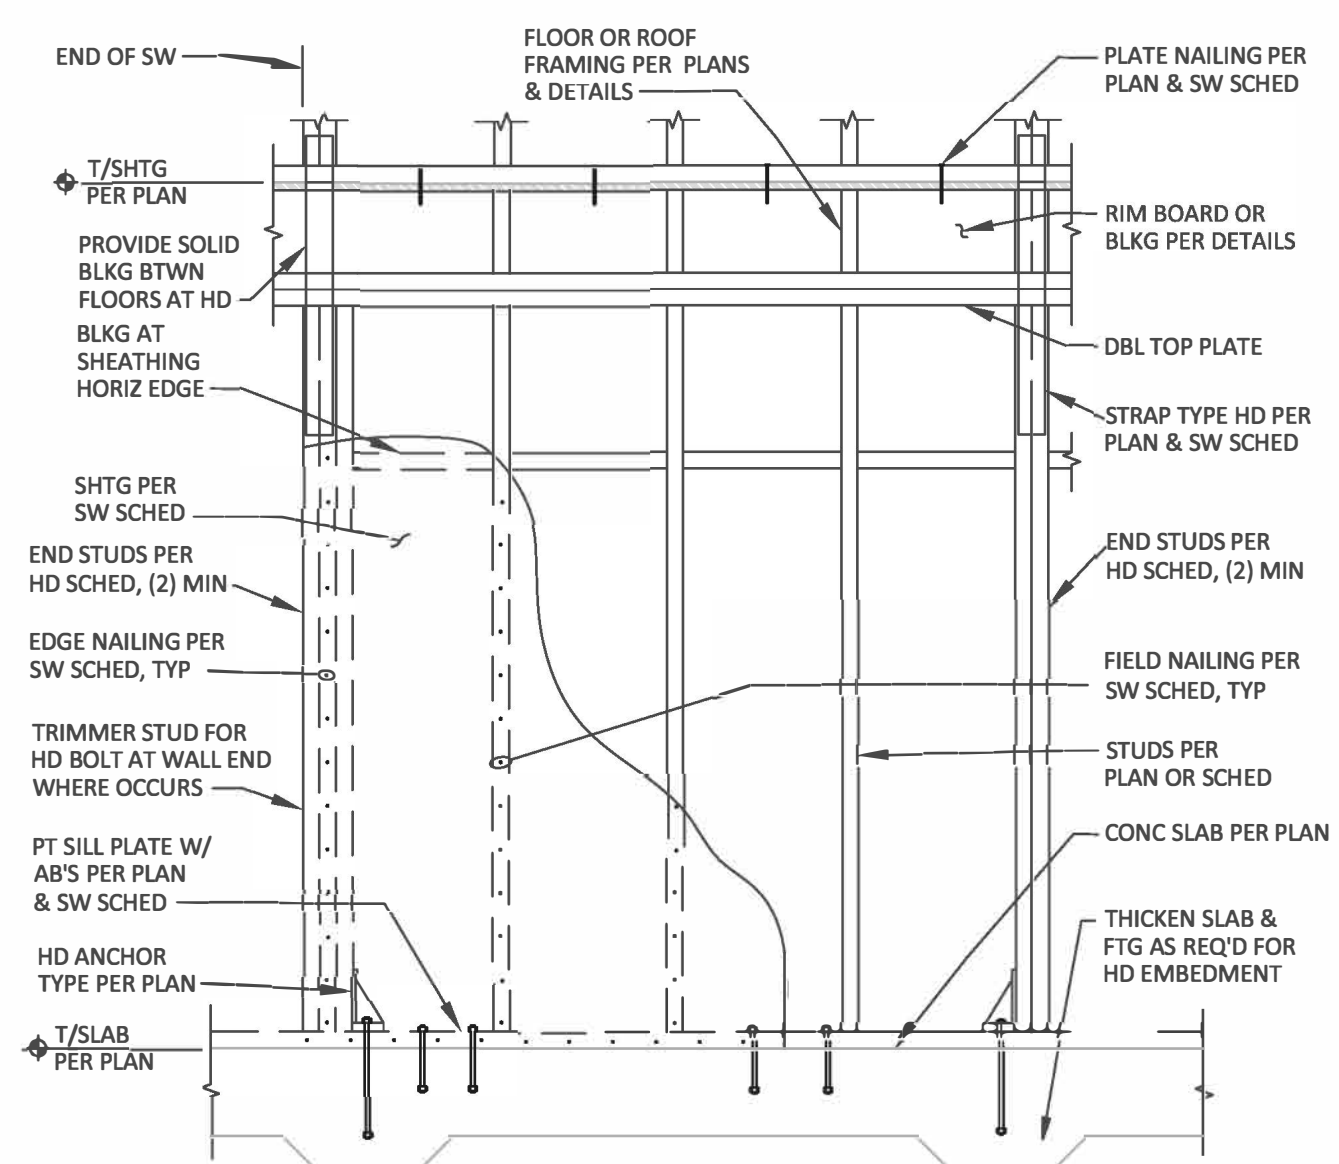
JOB#
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SHEET TITLE:
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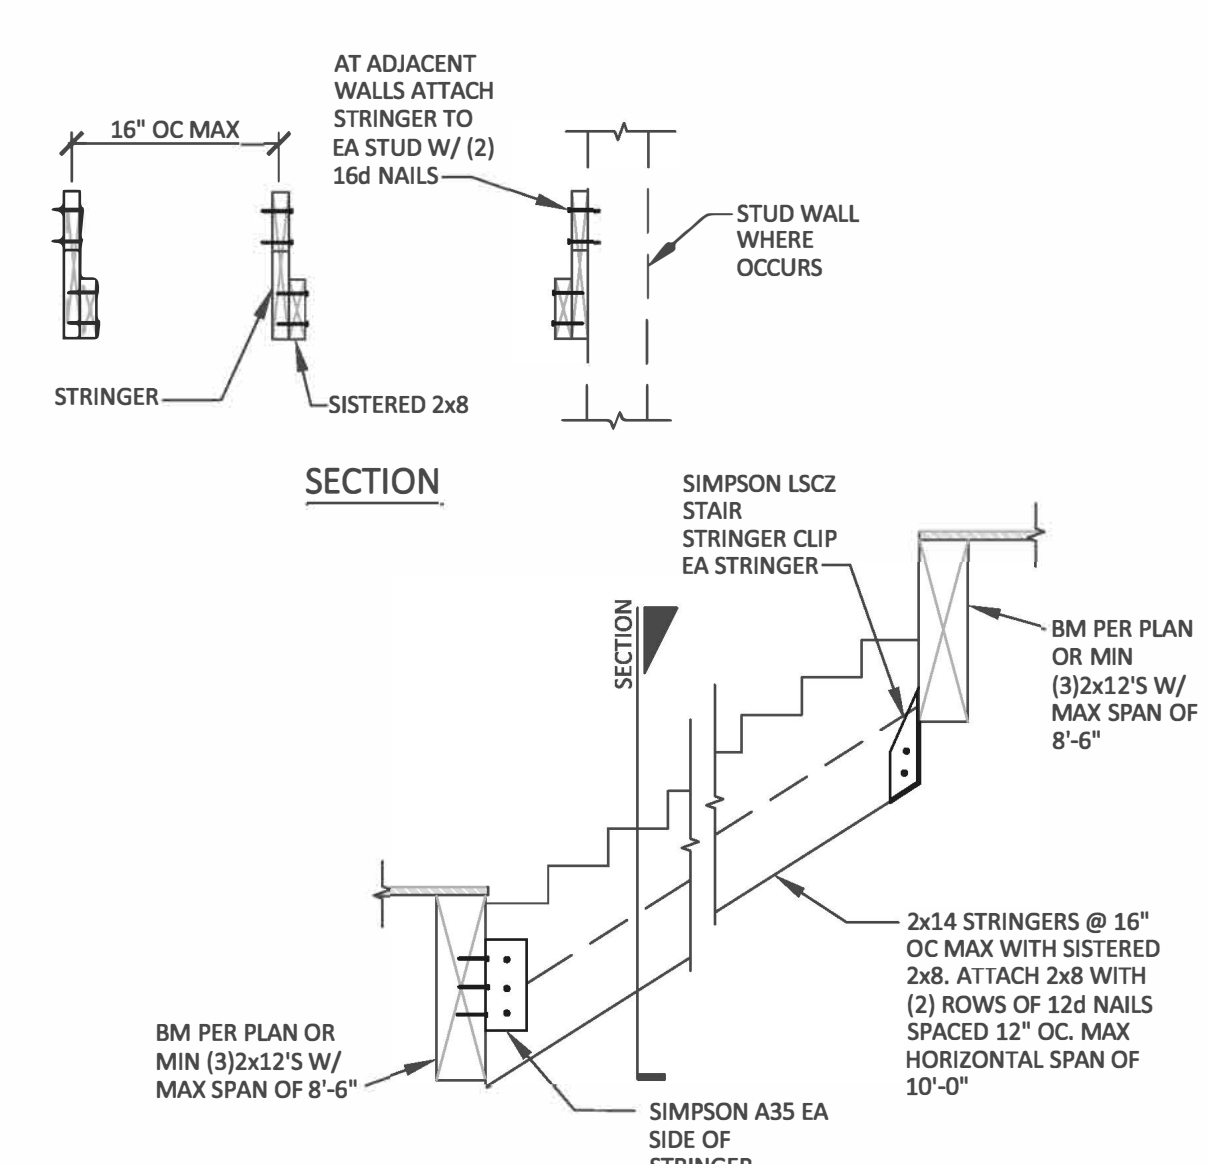
SHEET#:
S3.1

SCALE:
 AS SHOWN


DRAWN: MAF DATE: 08/12/2021 CHECKED: TJM DATE: 08/12/2021




8 STANDARD SHEAR WALL CONSTRUCTION
 NOT TO SCALE



7 STANDARD STAIR FRAMING
 NOT TO SCALE

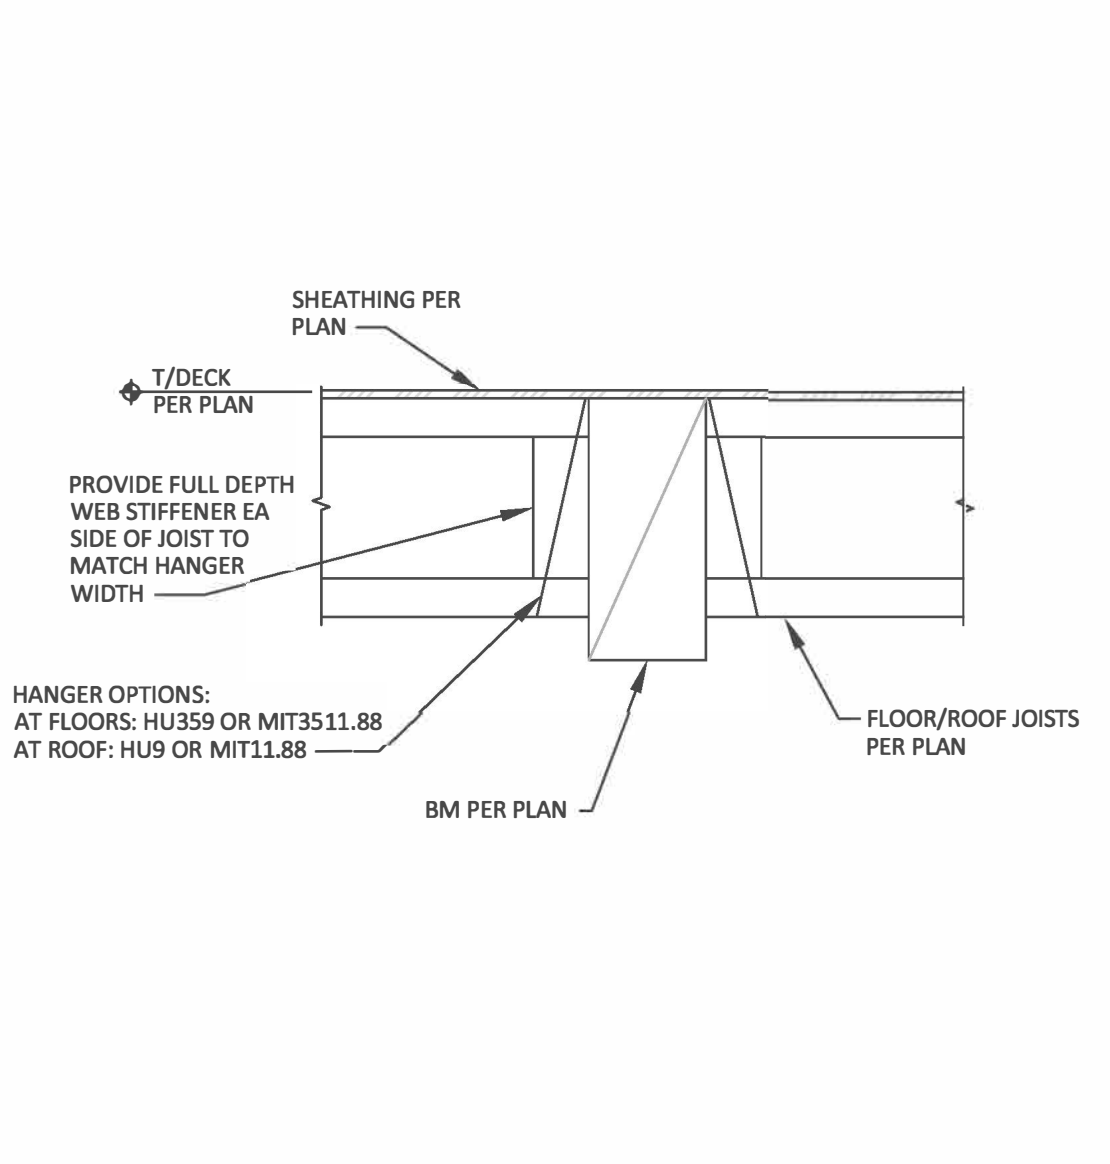

4 FLOOR JOIST BEARING AT BEAM
 NOT TO SCALE

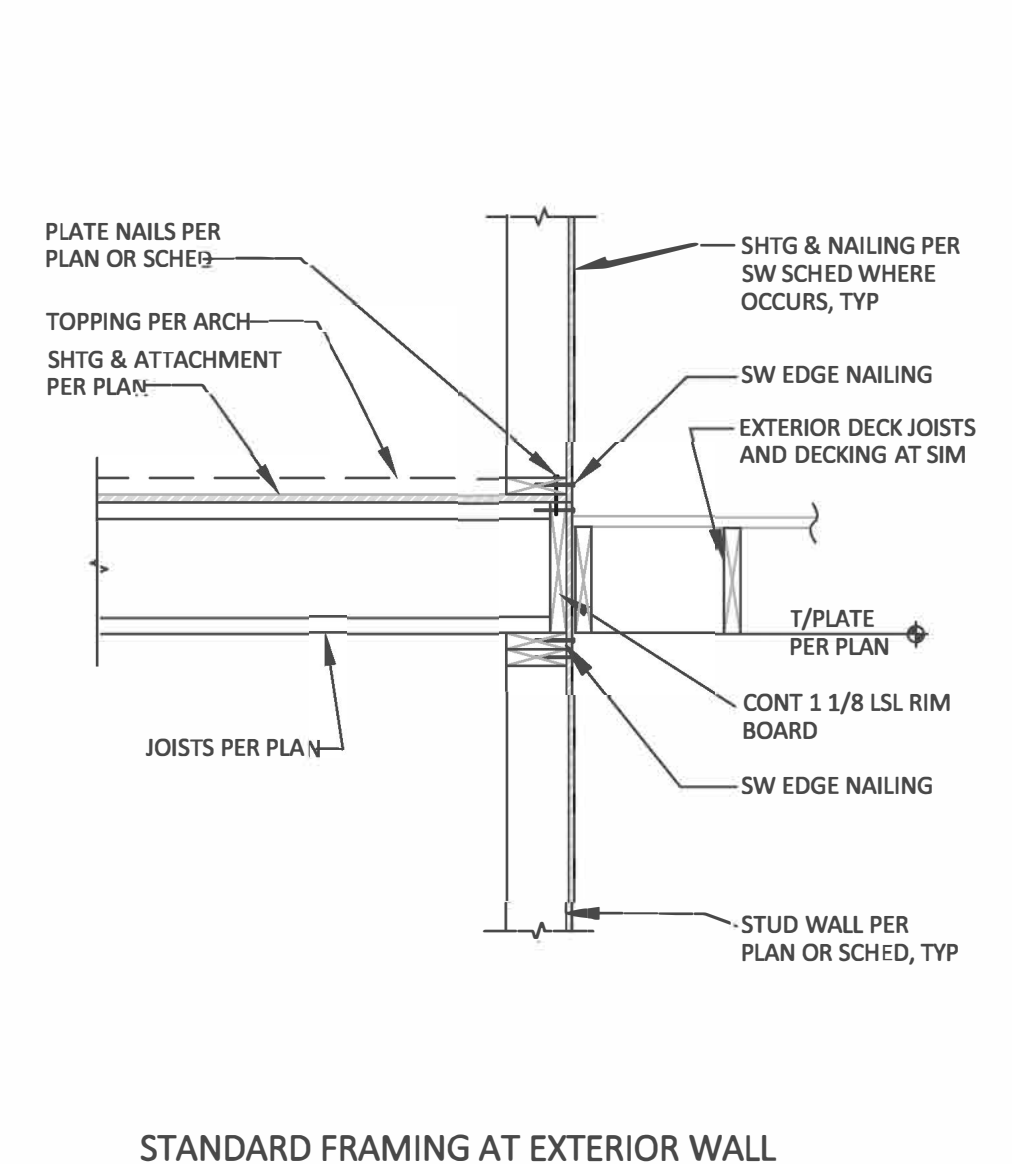


1 STANDARD FRAMING AT EXTERIOR WALL PERPENDICULAR TO JOIST
 NOT TO SCALE


	TYPE	NUMBER OF STUDS/POST	NAILS, SCREWS, OR BOLTS	DIAMETER	ANCHOR				CAPACITY, LBS	NOTES
					CONCRETE EMBEDMENT					
					STEM WALL		SPREAD FOOTING			
					CIP	ADHESIVE	CIP OR ADHESIVE			
WOOD TO CONCRETE	HDU2	(2) 2X	(6) SDS 1/4x2 1/2	5/8"	10"	10"	7"	3075		
	HDU4	(2) 2X	(10) SDS 1/4x2 1/2	5/8"	10"	10"	7"	4565		
	HDU5	(2) 2X	(14) SDS 1/4x2 1/2	5/8"	12"	15"	9"	5645		
	HDU8	6X	(20) SDS 1/4x2 1/2	7/8"	18"	-	11"	7870		
	HDU11		(30) SDS 1/4x2 1/2	1	18"	-	11"	9535		
WOOD TO WOOD	LSTA30	(2) 2X	(22) 10d	-	-	-	-	1640		
	MSTA30	(2) 2X	(22) 10d	-	-	-	-	2050		
	MST27	(2) 2X	(30) 16d	-	-	-	-	3700		
	MST148	(2) 2X	(48) 16d	-	-	-	-	5070		
	MSTC66	(2) 2X	(76) 16d	-	-	-	-	5860		

- NOTES:**
1. PROVIDE SHEAR WALL EDGE NAILING AT AT HOLD-DOWN STUDS/POST.
 2. CAPACITY BASED ON 2,500 PSI CONCRETE STRENGTH.
 3. STEM WALL SHALL BE MINIMUM 6 INCHES WIDE FOR 5/8" ANCHOR BOLTS AND 8" MINIMUM FOR 7/8" AND LARGER BOLTS.
 4. ALL HOLD-DOWNS AND STRAPS ARE BY SIMPSON STRONG TIE. CONTACT ENGINEER FOR ALTERNATE SUPPLIERS.
 5. CAST IN PLACE ANCHORS SHALL BE HEX HEAD OR A STANDARD "J" BOLT.
 6. ADHESIVE ANCHORS SHALL BE SIMPSON SET OR HILTI HY-150 ADHESIVE.
 7. PLACE 1/2 OF NAILS ABOVE FLOOR JOIST AND 1/2 BELOW FLOOR JOIST. NO NAILS IN CLEAR SPAN.

9 HOLD DOWN STRAP SCHEDULE
 NOT TO SCALE

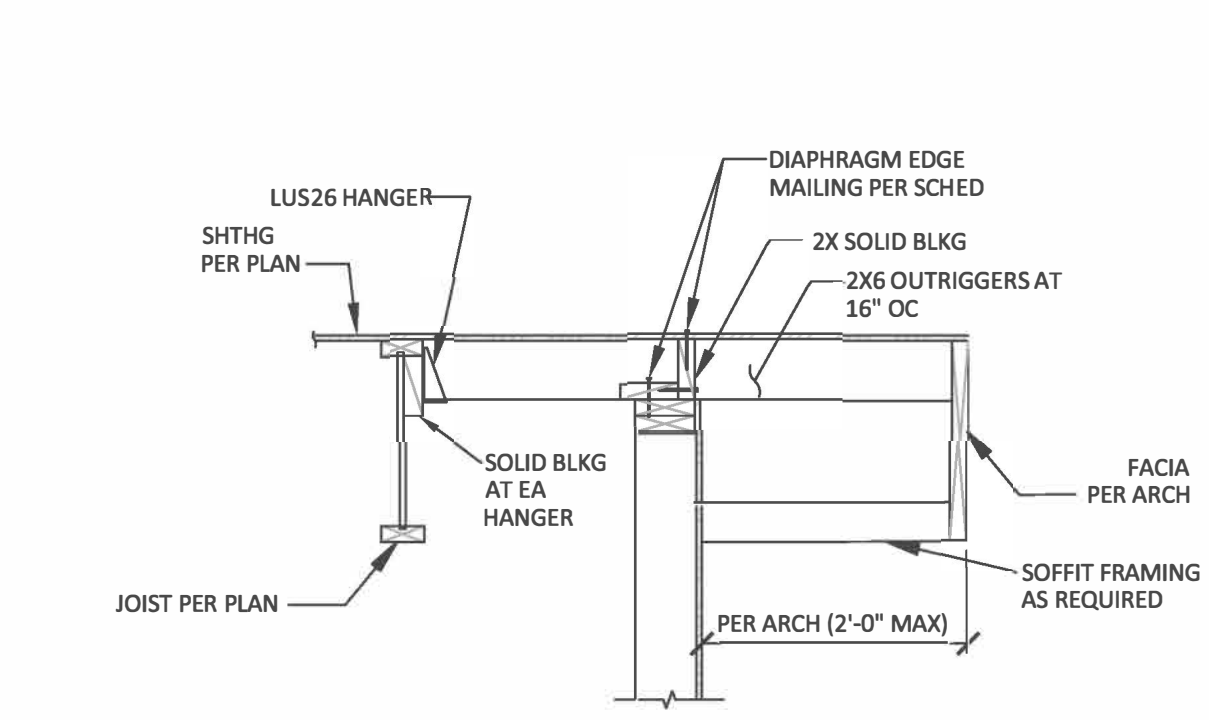

5 ROOF JOIST PARALLEL TO EXTERIOR WALL
 NOT TO SCALE

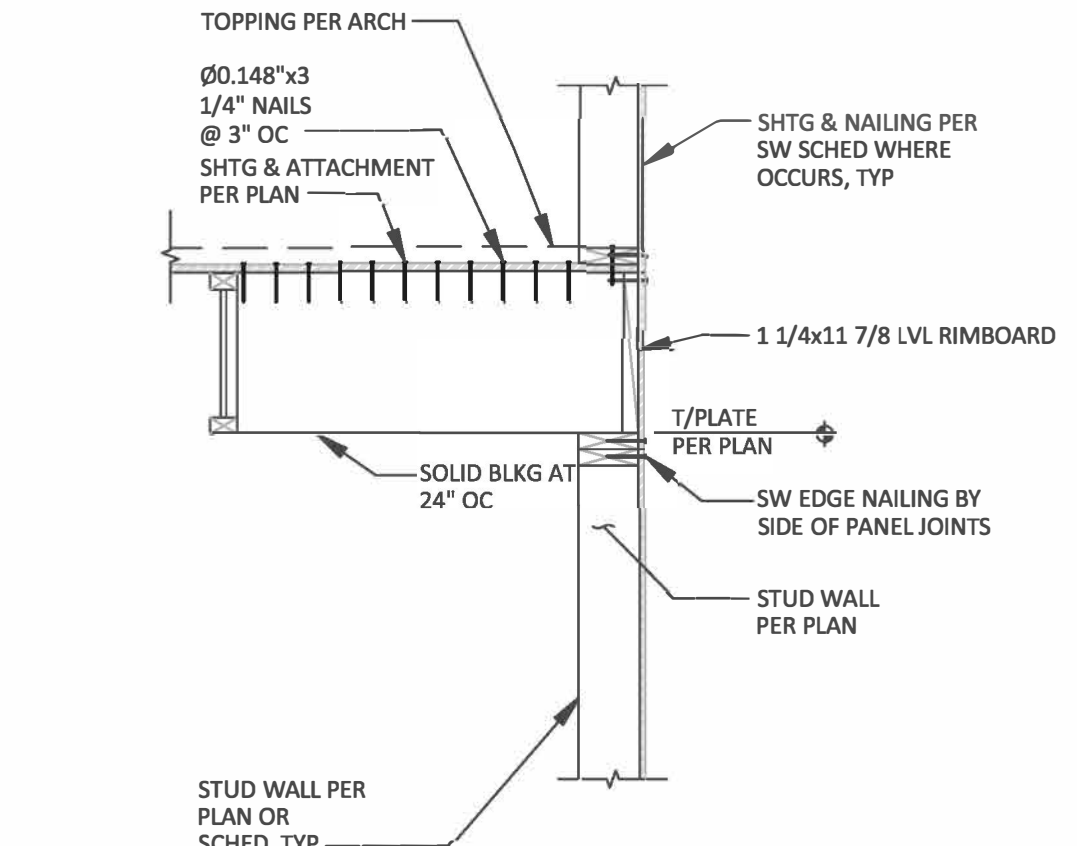


2 TYPICAL FRAMING AT EXTERIOR WALL PARALLEL TO JOIST
 NOT TO SCALE

- NOTES:**
1. STUDS SHALL BE SPACED A MAXIMUM OF 16" ON CENTER EXCEPT GYP WALLS MAY BE SPACED AT 24" ON CENTER.
 2. BLOCKING IS REQUIRED AT ALL PANEL EDGES.
 3. ALL SHEAR PANELS SHALL BE CONTINUOUS BETWEEN HORIZONTAL DIAPHRAGMS SW'S (ROOF TO FLOOR, FLOOR TO FLOOR, FLOOR TO FOUNDATION).
 4. REFERENCE GENERAL NOTES ON SHEET S1.0 FOR ADDITIONAL INFO.
 5. SHEATHING EDGE NAILING IS REQUIRED AT ALL HOLD-DOWN POST LOCATIONS. PROVIDE MIN (2) STUDS AT ENDS OF ALL. SEE HOLD-DOWN SCHEDULE FOR LARGER END STUDS AT HOLD-DOWNS.
 6. ALL NAILING WITH TWO ROWS SHALL HAVE 1 1/2" SPACING BETWEEN ROWS.
 7. NO. 6 X 1 1/4" DRYWALL SCREWS MAY BE USED IN LIEU OF 5D COOLER NAILS FOR GYPSUM SHEAR WALLS.
 8. 3X BLOCKING AT PANEL EDGES MAY BE SUBSTITUTED WITH (2) 2X BLOCKING NAILED TOGETHER WITH NAIL SIZE AND SPACING TO MATCH SILL NAILING
 9. A35 AND LTP5 CLIPS ARE SIMPSON PRODUCTS, BUT MAY BE SUBSTITUTED WITH APPROVED EQUIVALENTS.
 10. SOME SHEAR WALL TYPES MAY NOT BE USED ON THIS PROJECT.

6 SHEAR WALL SCHEDULE
 NOT TO SCALE

TYPE	WALL SHEATHING (APA RATED)	EDGE NAILING	FIELD NAILING	BLOCKING AT PANEL EDGES	FASTENERS (WHERE APPLICABLE)			SILL PLATE SIZE	CAPACITY, lbs/ft
					RIM JOIST TO PLATE BELOW	SILL PLATE TO RIM OR TOP PLATE BELOW	SILL ANCHORS		
W6	15/32"	8d AT 6" OC	8d AT 12" OC	2x	A35 OR LTP5 AT 16" OC	16d SINKER AT 8" OC	5/8" DIA AT 48" OC	2x	260
W4	15/32"	8d AT 6" OC	8d AT 12" OC	2x	A35 OR LTP5 AT 12" OC	16d SINKER AT 6" OC	5/8" DIA AT 48" OC	2x	380
W3	15/32"	8d AT 3" OC STAGGERED	8d AT 12" OC	3x OR (2) 2x	A35 OR LTP5 AT 10" OC	16d SINKER AT 4" OC	5/8" DIA AT 16" OC	2x	490
W2	15/32"	8d AT 2" OC STAGGERED	8d AT 12" OC	3x OR (2) 2x	A35 OR LTP5 AT 8" OC	(2) ROWS 16d SINKER AT 6" OC	5/8" DIA AT 32" OC	3x OR (2) 2x	640
2W4	15/32" BOTH SIDES	8d AT 4" OC STAGGERED	8d AT 12" OC	3x OR (2) 2x	A35 OR LTP5 AT 12" OC EACH SIDE	(2) ROWS 16d SINKER AT 6" OC	5/8" DIA AT 24" OC	3x OR (2) 2x	760
2W3	15/32" BOTH SIDES	8d AT 3" OC STAGGERED	8d AT 12" OC	3x OR (2) 2x	A35 OR LTP5 AT 10" OC EACH SIDE	(2) ROWS 16d SINKER AT 4" OC	5/8" DIA AT 24" OC	3x OR (2) 2x	980
2W2	15/32" BOTH SIDES	8d AT 2" OC STAGGERED	8d AT 12" OC	3x OR (2) 2x	A35 OR LTP5 AT 8" OC EACH SIDE	A35 OR LTP5 AT 8" OC EACH SIDE	5/8" DIA AT 16" OC	3x OR (2) 2x	1280
G7	1/2" GYP BOARD	5d COOLER @ 7" OC	5d COOLER @ 7" OC	2x	A35 OR LTP5 AT 24" OC	16d SINKER AT 8" OC	5/8" DIA AT 48" OC	2x	75
G4	1/2" GYP BOARD	5d COOLER @ 4" OC	5d COOLER @ 4" OC	2x	A35 OR LTP5 AT 24" OC	16d SINKER AT 8" OC	5/8" DIA AT 48" OC	2x	110

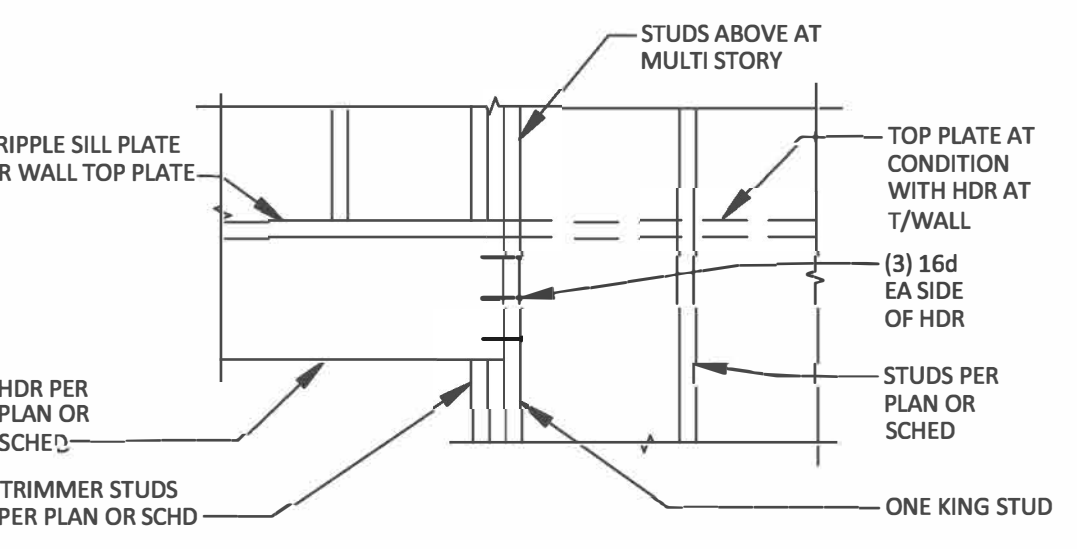

3 STANDARD HEADER PERPENDICULAR TO FLOOR JOIST
 NOT TO SCALE



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DRAWING ISSUE RECORD:

NO.	STATUS	DATE
	FOR PERMIT	08/12/2021

REVISION RECORD:

REV.	BY:	DESCRIPTION	DATE
1			
2			
3			
4			
5			

SEAL:




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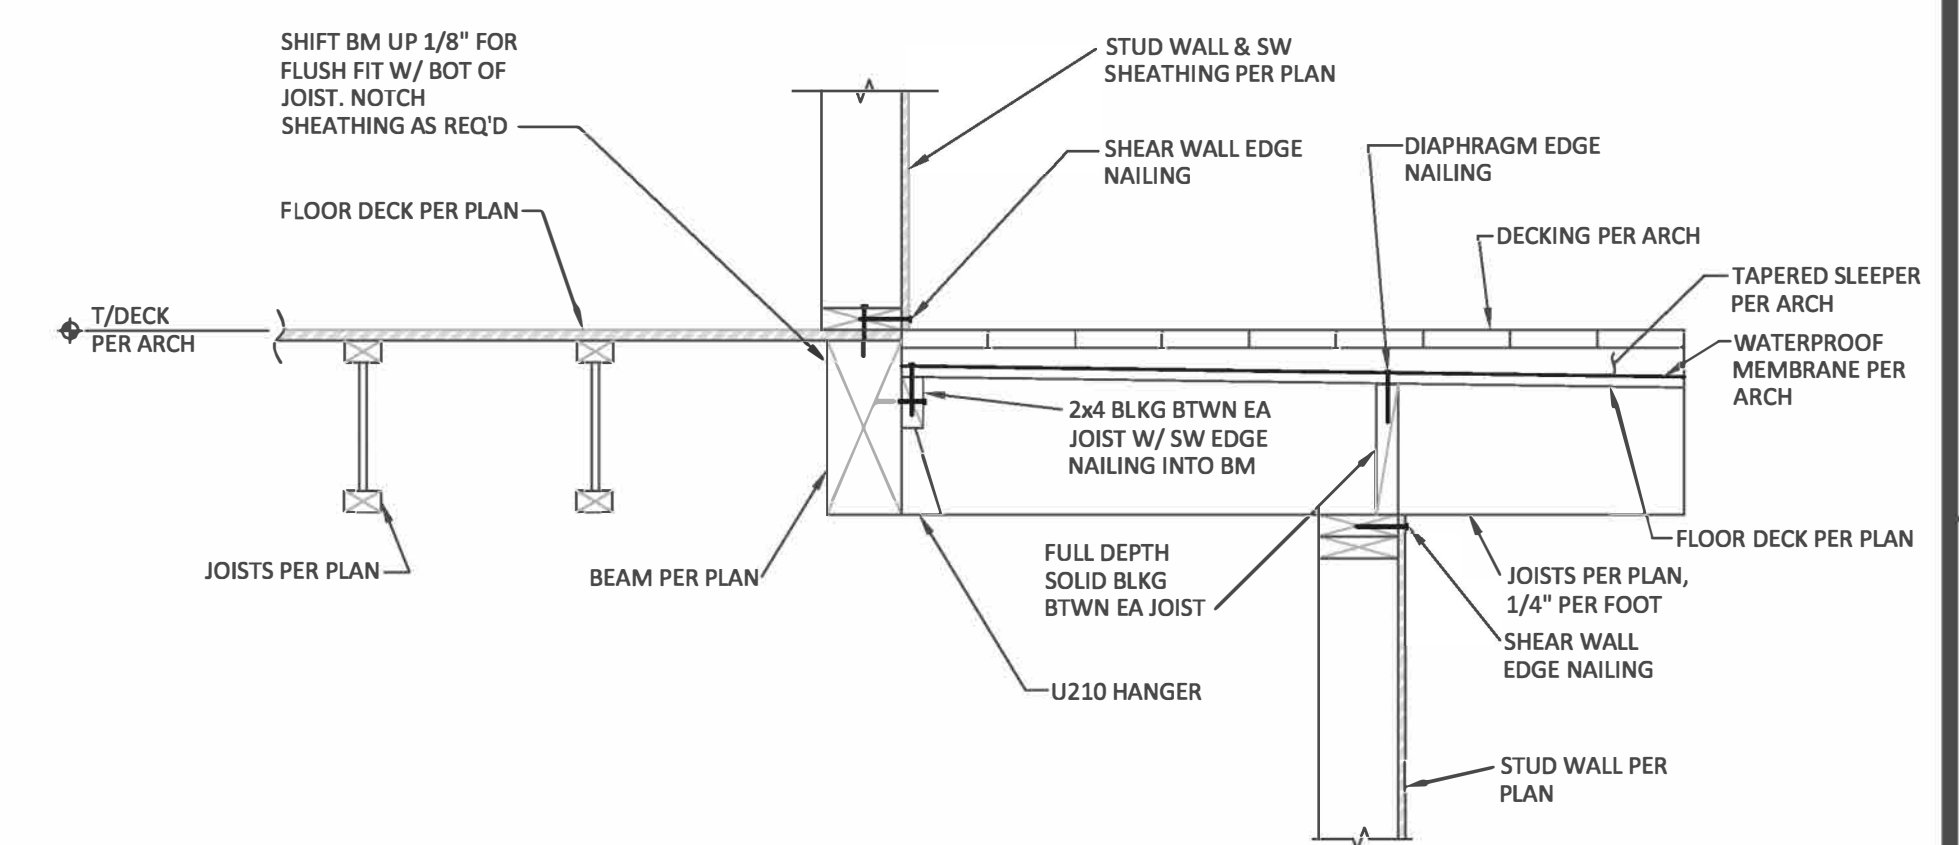
SHEET TITLE:
DETAILS

SHEET# **S3.2** SCALE:
 AS SHOWN


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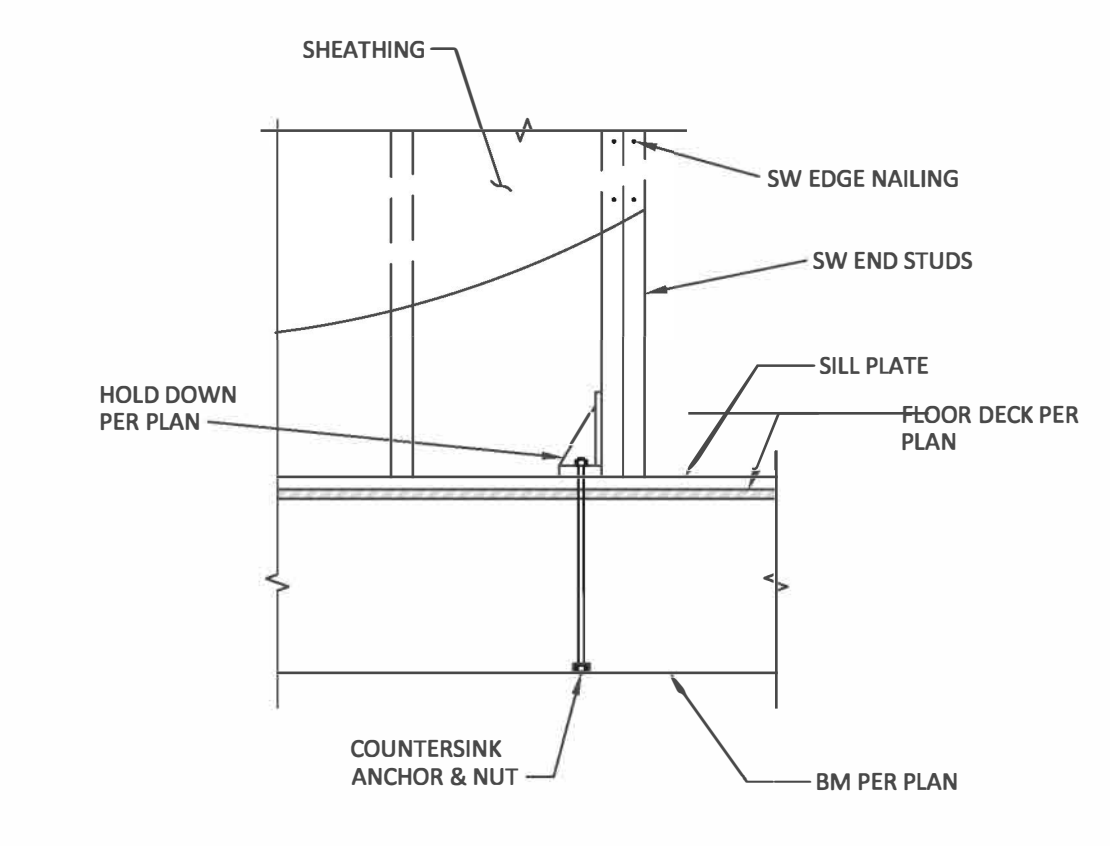
4 TYPICAL ROOF JOIST BEARING/OVERHANG
 NOT TO SCALE




1 SECTION AT DECK OVERHANG
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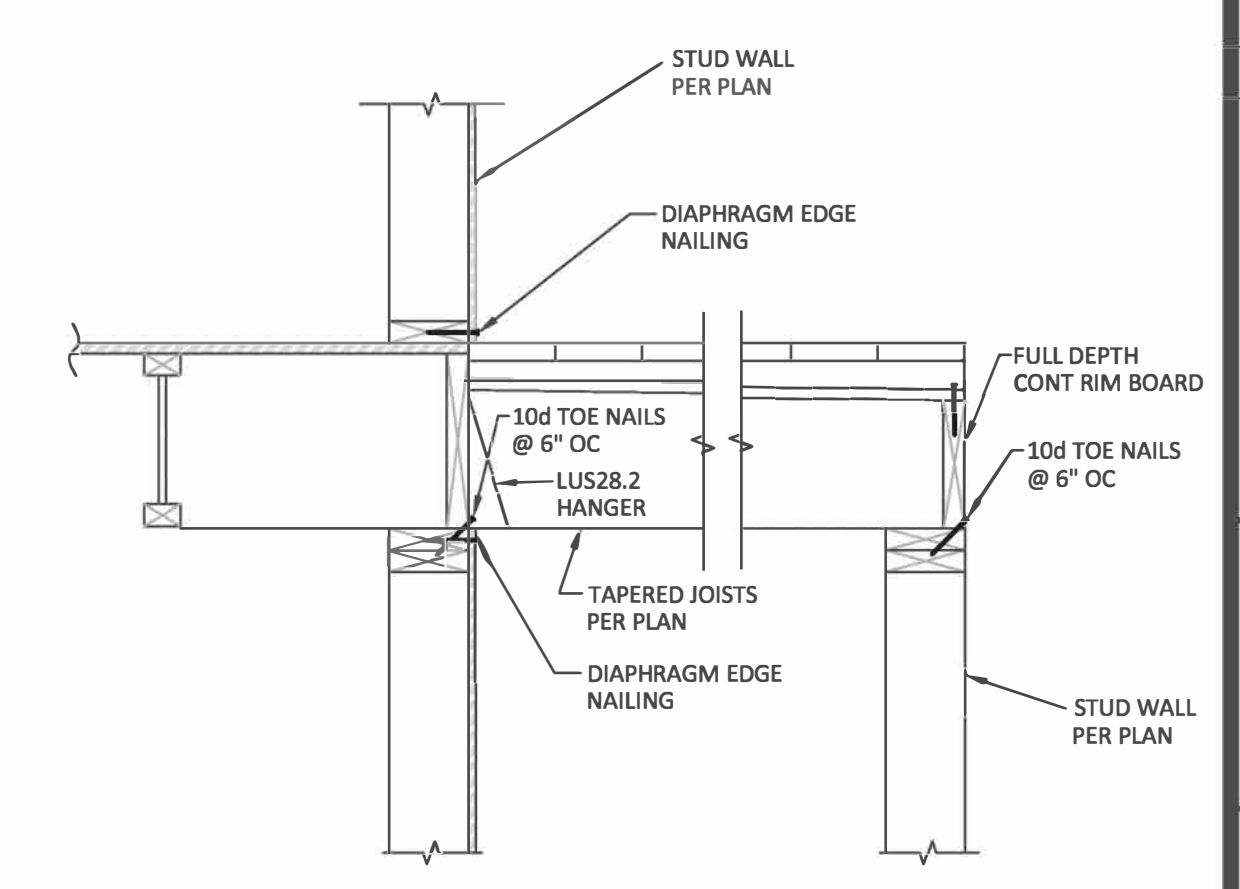
5 ROOF DRAG BEAM
 NOT TO SCALE

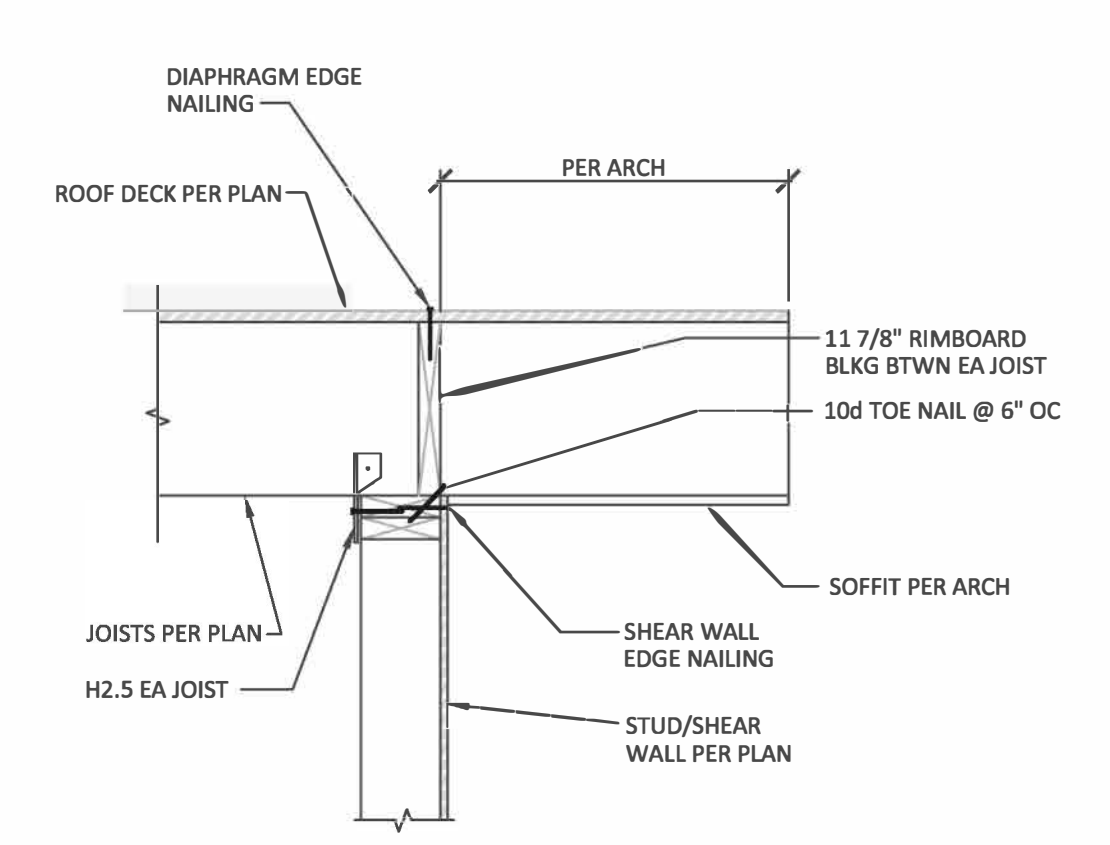

2 HOLD-DOWN ANCHOR AT BEAM
 NOT TO SCALE

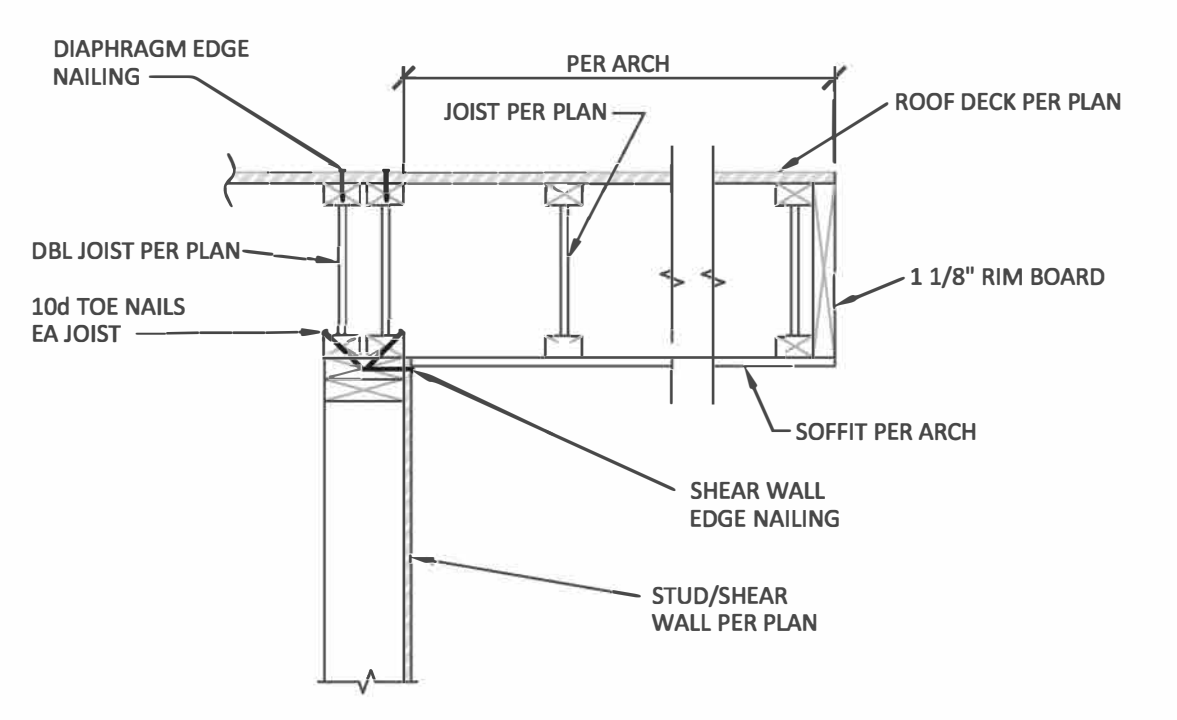

6 ROOF JOISTS AT CANTILEVERED GIRDER
 NOT TO SCALE

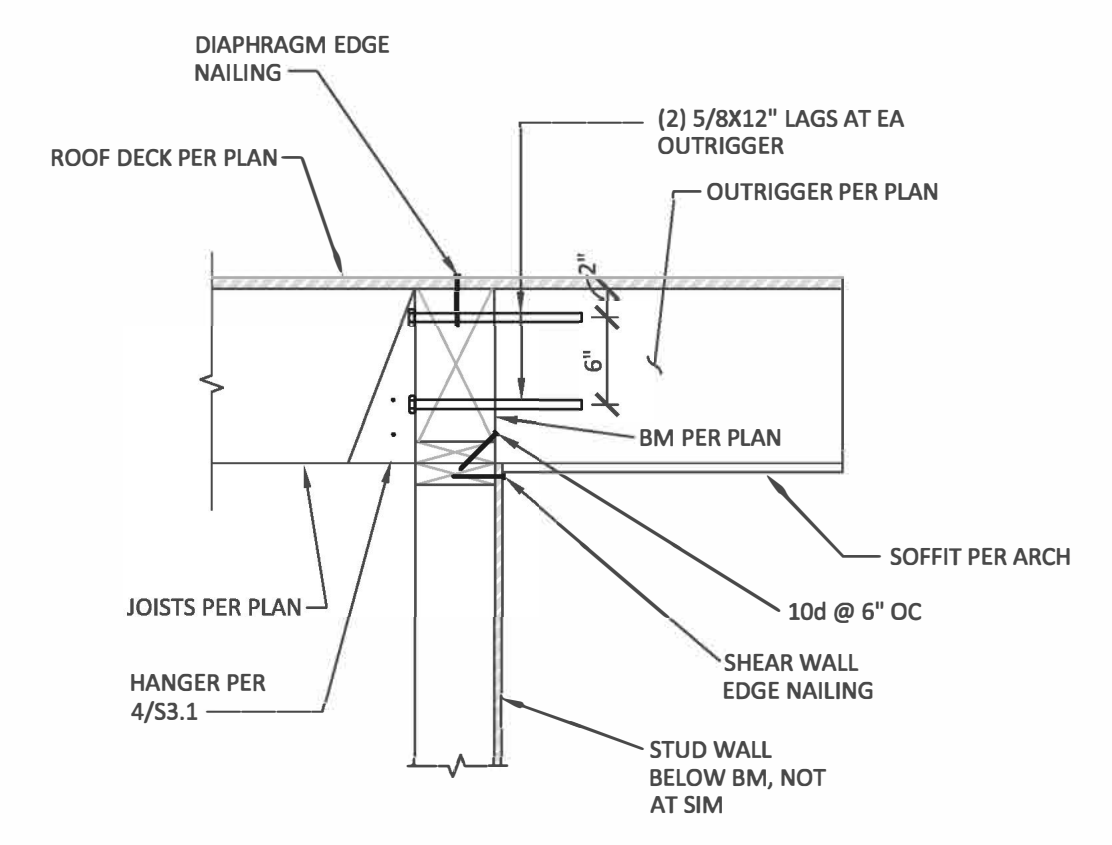

NOTE:
 REFERENCE 1/S3.2 AND 2/S3.1 FOR INFORMATION NOT SHOWN.

3 MAIN FLOOR DECK FRAMING
 NOT TO SCALE